
NOTE: THIS PROJECT SHALL BE CONSTRUCTED CONCURRENTLY WITH THE BRECKENRIDGE ON PARK NORTH DRAINAGE IMPROVEMENT PROJECT.

BRECKENRIDGE ON PARK SOUTH DRAINAGE IMPROVEMENTS

PLANS PREPARED FOR:

CITY OF

THIS PLAN SET IS FOR INFORMATIONAL PURPOSES ONLY. **NOT FOR CONSTRUCTION**.

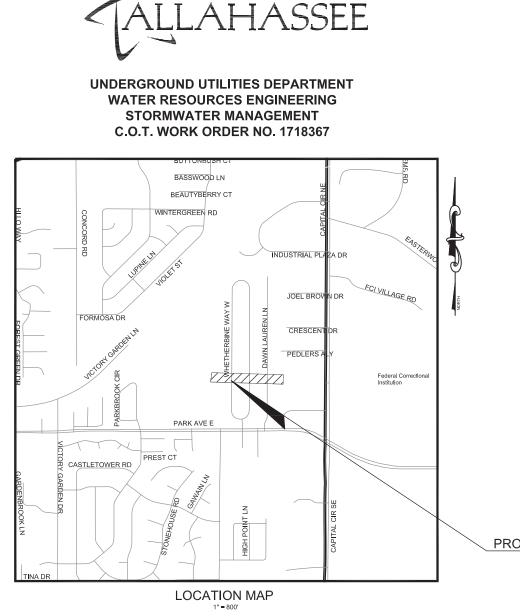

NORTH AMERICAN VERTICAL DATUM OF 1988

PLANS PREPARED BY:

EUTAW, INC.

2822 REMINGTON GREEN CIRCLE, SUITE 202 TALLAHASSEE, FLORIDA 32308 (850) 383-0400 WWW.EUTAWINC.COM ENGINEER OF RECORD:

LANE P. LUCAS, P.E. FLORIDA PE #53936

GOVERNING STANDARDS AND SPECIFICATIONS:

FLORIDA DEPARTMENT OF TRANSPORTATION, DESIGN STANDARDS DATED 2017-2018 AND STANDARD SPECIFICATIONS FOR ROAD AND BRIDGE CONSTRUCTION DATED 2018, AS AMENDED BY CONTRACT DOCUMENTS.

ATTENTION IS DIRECTED TO THE FACT THAT THESE PLANS MAY HAVE BEEN ALTERED IN SIZE BY REPRODUCTION. THIS MUST BE CONSIDERED WHEN OBTAINING SCALED DATA.

	REVISIONS						
NO.	DESCRIPTION	BY	DATE				

INDEX OF SHEETS

SHEET NO.

2

3

-5

6

7-9 10

11-12

13-14

15

16

17

18

21

19-20

SHEET DESCRIPTION


COVER SHEET DRAINAGE MAP GENERAL NOTES PAY ITEM NOTES **TYPICAL SECTIONS & DETAILS** PROJECT LAYOUT **PLAN & PROFILE** DRAINAGE STRUCTURES CROSS SECTIONS **DRIVEWAY & DRAINAGE DETAILS RETAINING WALL DETAILS** SOIL SURVEY UTILITY ADJUSTMENTS STORMWATER POLLUTION PREVENTION PLAN TREE PROTECTION/REMOVAL & EROSION CONTROL TRAFFIC CONTROL PLAN

PROJECT LOCATION

APPROVED FOR CONSTRUCTION

STORMWATER MANAGEMENT DIVISION

DATE:

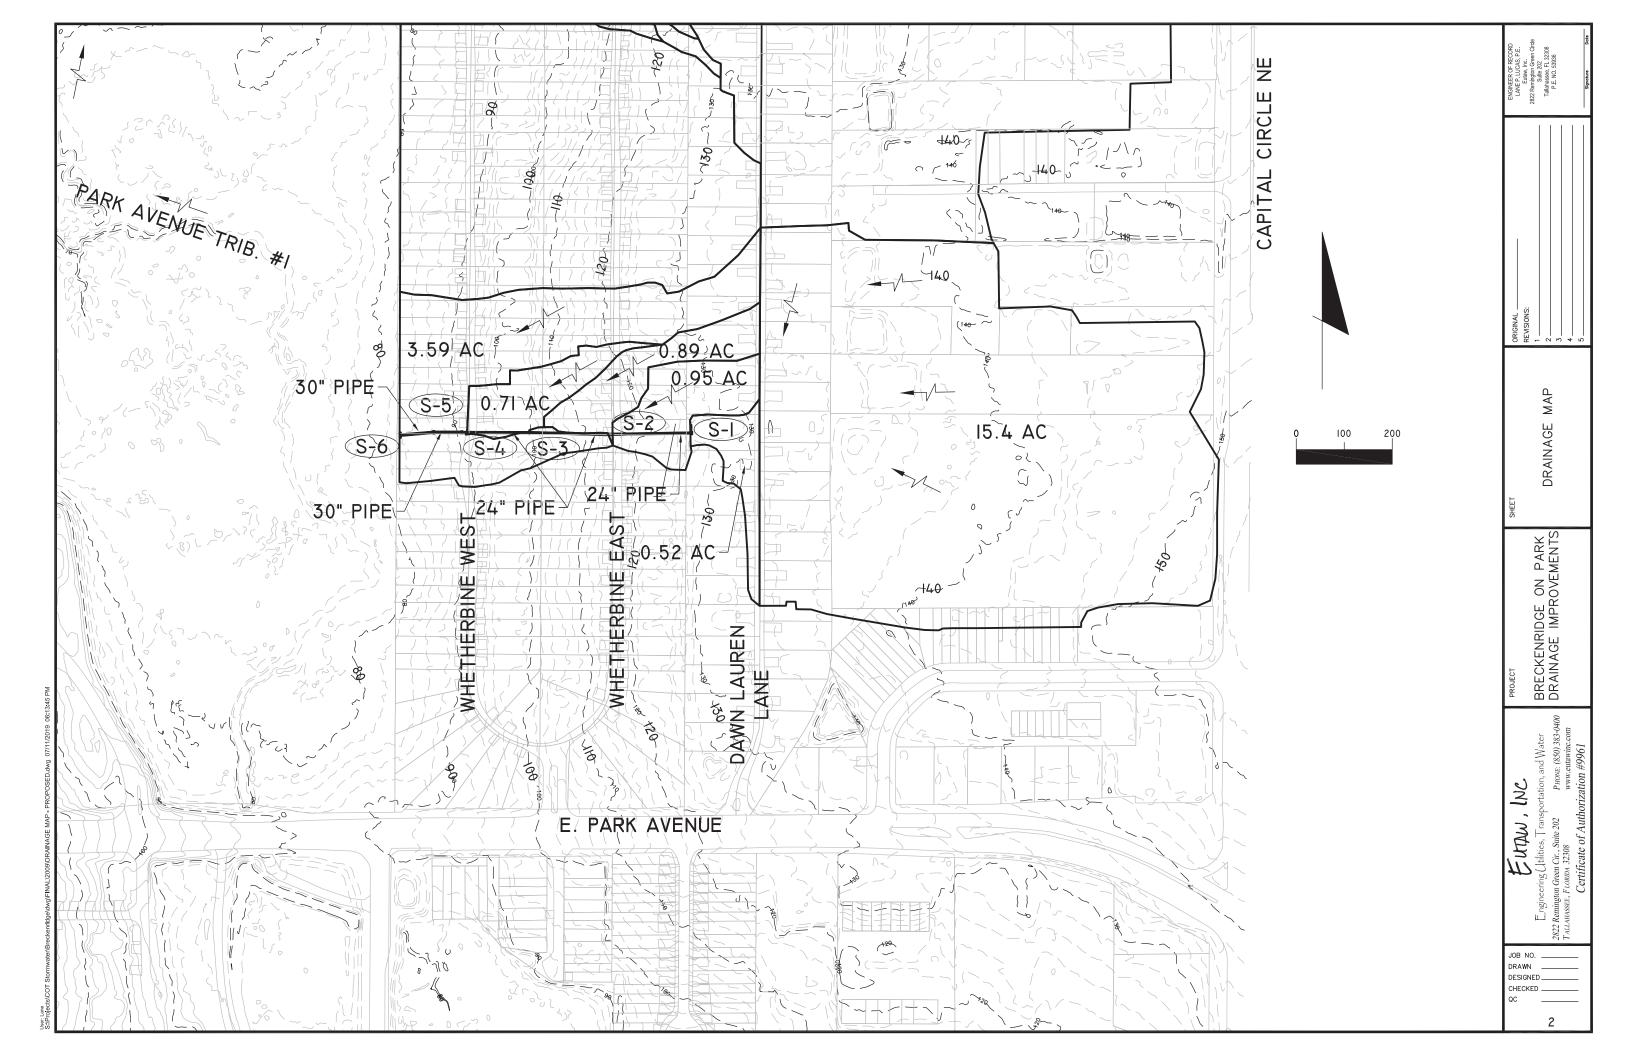

GENERAL NOTES:

- THE CONTRACTOR SHALL HAVE ALL REQUIRED PERMITS IN-HAND PRIOR TO BEGINNING CONSTRUCTION, AND SHALL PERFORM ALL WORK IN ACCORDANCE WITH THE REQUIREMENTS OF THE PERMITS OBTAINED BY THE CITY AND THOSE PERMITS OBTAINED BY THE CONTRACTOR.
- AT LEAST THREE CALENDAR DAYS PRIOR TO THE PRECONSTRUCTION CONFERENCE; THE CONTRACTOR SHALL SUBMIT TO THE ENGINEER FOR APPROVAL A TENTATIVE BASE CONSTRUCTION SCHEDULE, A PRECONSTRUCTION SURVEY A TRAFFIC CONTROL PLAN, AND A SEDIMENT AND EROSION CONTROL PLAN. NO WORK SHALL BEGIN PRIOR TO APPROVAL OF THE CONSTRUCTION SCHEDULE, PRECONSTRUCTION SURVEY, TRAFFIC CONTROL PLAN, AND SEDIMENT AND EROSION CONTROL PLAN.
- THE CONSTRUCTION SCHEDULE SHALL DESCRIBE IN DETAIL HOW THE CONSTRUCTION IS TO BE PHASED, ESTABLISH START AND FINISH DATES FOR ALL SIGNIFICANT CONSTRUCTION ACTIVITIES, AND IDENTIFY ALL CONTROLLING ITEMS OF WORK. THE SCHEDULE IS TO BE APPROVED BY THE ENGINEER, AND SHALL BE UPDATED ON A MONTHLY BASIS TO REFLECT ACTUAL WORK PROGRESS. THE UPDATED SCHEDULE SHALL BE SUBMITTED TO THE ENGINEER NO LATER THAN THREE DAYS PRIOR TO EACH SCHEDULED MONTHLY PROGRESS MEETING. PAYMENT FOR PREPARING, UPDATING AND SUBMITTING THE SCHEDULE SHALL BE INCLUDED IN THE PAY ITEM FOR MOBILIZATION.
- THE PRECONSTRUCTION SURVEY SHALL VERIFY THE CONTROL POINTS AND BENCH MARK ELEVATIONS PROVIDED BY THE ENGINEER AND SHALL ALSO ESTABLISH THE LOCATION AND DESCRIPTION OF ALL ADDITIONAL REFERENCE POINTS AND THE LOCATIONS. DESCRIPTIONS. AND ELEVATIONS OF ALL ADDITIONAL BENCHMARKS TO BE USED IN CONSTRUCTING THE PROJECT. THE SURVEY SHALL BE SIGNED AND SEALED BY A PROFESSIONAL SURVEYOR AND MAPPER REGISTERED IN THE STATE OF FLORIDA. SIGNIFICANT INCONSISTENCIES BETWEEN THE FIELD NOTES AND THE CONTROL POINTS AND BENCH MARK ELEVATIONS PROVIDED BY THE ENGINEER SHALL IMMEDIATELY BE BROUGHT TO THE ATTENTION OF THE ENGINEER FOR RESOLUTION PRIOR TO ISSUANCE OF THE NOTICE TO PROCEED. PAYMENT SHALL BE INCLUDED IN THE PAY ITEM FOR MOBILIZATION.
- THE GEOTECHNICAL INFORMATION SHOWN ON THE DRAWINGS WAS OBTAINED FOR USE IN ESTABLISHING DESIGN CRITERIA FOR THE PROJECT. THIS INFORMATION MAY NOT ACCURATELY REFLECT ACTUAL SOIL CONDITIONS AS TO THE DEPTH, EXTENT OR CHARACTER OF THE MATERIAL TO BE ENCOUNTERED IN CONSTRUCTION OF THE PROJECT. IT IS THE RESPONSIBILITY OF THE CONTRACTOR TO MAKE SUCH EXAMINATION OF THE SITE OF THE WORK AS MAY BE NECESSARY TO DETERMINE THE CONDITIONS UNDER WHICH THE WORK IS TO BE PERFORMED
- THE CONTRACTOR IS RESPONSIBLE FOR PRESERVING ALL PROPERTY CORNERS AND MONUMENTS SHOWN ON THE DRAWINGS OR FOUND DURING CONSTRUCTION. IF A PROPERTY CORNER OR MONUMENT IS DESTROYED OR DISTURBED, THE CONTRACTOR WILL HAVE IT REPLACED AND CERTIFIED BY A PROFESSIONAL SURVEYOR AND MAPPER REGISTERED IN THE STATE OF FLORIDA. ALL COSTS FOR PRESERVING, REPLACING AND CERTIFYING PROPERTY CORNERS AND MONUMENTS WILL BE INCLUDED IN THE PAY ITEM FOR MOBILIZATION.
- ANY NATIONAL GEODETIC SURVEY MONUMENT WITHIN THE LIMITS OF CONSTRUCTION MUST BE PROTECTED. IF IN DANGER OF DAMAGE. THE CONTRACTOR SHALL IMMEDIATELY NOTIFY THE ENGINEER AND:

FDEP, BUREAU OF SURVEY AND MAPPING, MS 100 3900 COMMONWEALTH BLVD. TALLAHASSEE, FLORIDA 32399 850-245-2555 (OFFICE) 850-245-2572 (FAX)

THE CONTRACTOR IS RESPONSIBLE FOR THE PROTECTION OF ALL UTILITIES. THE INFORMATION SHOWN ON THESE DRAWINGS CONCERNING TYPE AND LOCATION OF UNDERGROUND AND OTHER UTILITIES IS BASED ON INFORMATION PROVIDED BY THE UTILITY OWNERS, AVAILABLE RECORDS, AND SURVEYED FIELD INFORMATION. THE INFORMATION MAY NOT REFLECT ACTUAL CONDITIONS, INCLUDE ALL UTILITIES IN THE AREA, EITHER IN SERVICE OR ABANDONED, OR SHOW THE UTILITIES IN THE CORRECT HORIZONTAL OR VERTICAL LOCATIONS. THE CONTRACTOR SHALL MAKE HIS OWN DETERMINATION AS TO THE TYPE AND LOCATION OF UTILITIES AS NECESSARY TO ESTABLISH THEIR LOCATIONS AND AVOID DAMAGE. THE FOLLOWING UTILITIES. SHOULD BE CONTACTED FOR INFORMATION CONCERNING TYPE AND LOCATION OF THEIR FACILITIES. THE LIST MAY NOT INCLUDE ALL UTILITIES IN THE AREA.

SUNSHINE STATE ONE-CALL OF FLORIDA 811 OR 800-432-4770 (5 DAYS NOTIFICATION PRIOR TO CONSTRUCTION) CITY OF TALLAHASSEE/ELECTRICAL UTILITY 850-891-5091 CITY OF TALLAHASSEE/GAS UTILITY 850-891-5100 CITY OF TALLAHASSEE/WATER UTILITY 850-891-6107 CITY OF TALLAHASSEE/SEWER UTILITY 850-891-6107 COMCAST (CABLE TELEVISION) 850-574-4060 CENTURYLINK (TELEPHONE) 850-599-1502 AT&T (COMMUNICATIONS) 850-242-9087 SOUTHERN LIGHT (COMMUNICATIONS) 251-662-1170

- PRIOR TO ANY SCHEDULED INTERRUPTION OF UTILITY SERVICE, THE 9. CONTRACTOR SHALL COORDINATE SUCH INTERRUPTION WITH THE UTILITY PROVIDER AND SHALL PROVIDE A MINIMUM 24-HOUR NOTICE TO THE AFFECTED PARTIES. IN THE CASE OF A WATER MAIN SHUT DOWN, A MINIMUM 24-HOUR NOTICE ALSO SHALL BE PROVIDED TO THE TALLAHASSEE FIRE DEPARTMENT. THE CONTRACTOR SHALL NOTIFY THE ELECTRIC UTILITY A MINIMUM OF TWO WEEKS PRIOR TO CONSTRUCTION IN THE VICINITY OF THEIR FACILITIES.
- 10. THE CONTRACTOR SHALL NOTIFY THE GAS UTILITY (850-891-5100) A MINIMUM OF TWO WORKING DAYS PRIOR TO ANY EXCAVATION IN THE VICINITY OF GAS MAINS, AS REQUIRED BY CHAPTER 77-153 OF THE FLORIDA STATUTES. A GAS DEPARTMENT INSPECTOR WILL BE ON SITE WHEN WORK ACTIVITIES TAKE PLACE NEAR GAS MAINS. A MINIMUM OF 72 HOURS NOTICE SHALL BE PROVIDED FOR ANY REQUEST FOR GAS MAIN EXPOSURE OR ADJUSTMENT.
- 11. ALL UTILITIES IN CONFLICT WITH CONSTRUCTION ARE TO BE ADJUSTED OR RELOCATED BY OTHERS UNLESS NOTED OTHERWISE ON THE DRAWINGS OR DIRECTED BY THE ENGINEER
- 12. WHERE THE REQUIRED MINIMUM SEPARATION BETWEEN UTILITIES IS SPECIFIED, THE DISTANCE SHALL BE MEASURED FROM OUTSIDE OF PIPE TO OUTSIDE OF PIPE.
- 13. LIMITS OF CONSTRUCTION ARE DEFINED IN THE PLANS AND CONSIST OF ROADWAY RIGHTS-OF-WAY, CITY OF TALLAHASSEE PROPERTIES, DRAINAGE RIGHTS-OF-WAY, PERMANENT DRAINAGE AND/OR UTILITY EASEMENTS, AND TEMPORARY CONSTRUCTION EASEMENTS.
- 14. NO TRENCHES WILL BE ALLOWED TO REMAIN OPEN OVERNIGHT.
- 15. ALL EXISTING DRAINAGE STRUCTURES AND PIPES, PAVEMENT, SIDEWALKS, CURBS, ETC., WITHIN THE LIMITS OF CONSTRUCTION ARE TO REMAIN UNLESS OTHERWISE NOTED ON THE DRAWINGS OR DIRECTED BY THE ENGINEER. ALL DRAINAGE STRUCTURES, PIPES, PAVEMENT, SIDEWALKS, CURBS, ETC., THAT ARE TO REMAIN THAT ARE DAMAGED DURING CONSTRUCTION ARE THE RESPONSIBILITY OF THE CONTRACTOR AND IF DAMAGED DURING CONSTRUCTION SHALL BE REPAIRED OR REPLACED WITH THE SAME TYPE AND MATERIAL AT NO COST TO THE CITY.
- 16. ALL STORM MANHOLES OR STRUCTURES DESIGNATED TO BE ABANDONED IN PLACE SHALL BE REMOVED TO A MINIMUM OF THREE FEET BELOW GRADE AND FILLED WITH COMPACTED SAND
- 17. EXISTING CONCRETE AND ASPHALTIC CONCRETE DRIVEWAYS AND SIDEWALKS SHALL BE SAW-CUT AS REQUIRED FOR CONSTRUCTION.
- 18. ALL SIDEWALKS AND CURB RAMPS REMOVED DURING CONSTRUCTION SHALL BE RECONSTRUCTED TO MEET CURRENT ADA STANDARDS.
- 19. THE CONTRACTOR SHALL PUT FORTH EVERY REASONABLE EFFORT TO MINIMIZE DISRUPTION AND DISTURBANCE OF ADJACENT PROPERTIES. ACCESS BY PROPERTY OWNERS AND RESIDENTS TO THEIR PROPERTY SHALL BE MAINTAINED AT ALL TIMES, AND ANY BARRICADING OF ACCESS MUST BE COORDINATED WITH THE AFFECTED PROPERTY OWNERS AND RESIDENTS
- 20. ALL FENCES IN CONFLICT WITH CONSTRUCTION SHALL BE REMOVED AND REPLACED IN THEIR ORIGINAL LOCATIONS OR IN OTHER LOCATIONS AS DIRECTED BY THE ENGINEER. THE CONTRACTOR MAY, AT HIS OPTION, USE NEW FENCING MATERIAL OF THE SAME TYPE THAT WAS REMOVED OR REUSE THE FENCING MATERIAL THAT WAS REMOVED IF IT IS UNDAMAGED BY CONSTRUCTION ACTIVITIES. ALL FENCES DAMAGED BY CONSTRUCTION ACTIVITIES ARE TO BE REPLACED WITH NEW FENCING MATERIAL OF THE SAME TYPE THAT WAS REMOVED.
- 21. THE CONTRACTOR SHALL EXERCISE DUE CARE IN THE REMOVAL OF EXISTING FENCES TO MAINTAIN SECURITY AT THE AFFECTED PROPERTIES AND TO ENSURE THE SAFETY OF PETS, ANIMALS AND CHILDREN, IF IN THE OPINION OF THE ENGINEER, REMOVAL OF A FENCE WILL RESULT IN AN UNACCEPTABLE REDUCTION IN SECURITY OR SAFETY, THE CONTRACTOR SHALL INSTALL A TEMPORARY FENCE AS DIRECTED BY THE ENGINEER

PRIOR TO REMOVAL OF THE EXISTING FENCE. THE TEMPORARY FENCE SHALL REMAIN IN PLACE UNTIL THE PERMANENT FENCE IS INSTALLED

- 22. THE CONTRACTOR IS RESPONSIBLE FOR THE PROTECTION OF ALL TREES AND LANDSCAPING ON ADJACENT PROPERTIES, AND WILL BE SOLELY LIABLE FOR DAMAGE TO VEGETATION ON PROPERTIES ADJACENT TO CONSTRUCTION WORK ZONES. ALL TREES WITHIN THE LIMITS OF CONSTRUCTION THAT ARE NOT IDENTIFIED ON THE PLANS TO BE REMOVED SHALL BE PROTECTED TO THE MAXIMUM EXTENT PRACTICABLE. TREE PROTECTION BARRICADES SHALL BE INSTALLED AND MAINTAINED AROUND ALL TREES THAT ARE TO BE PROTECTED AS SHOWN ON THE DRAWINGS OR AS DIRECTED BY THE ENGINEER.
- 23. THE CONTRACTOR SHALL NOT DISTURB GRASSING OR LANDSCAPING OUTSIDE CONSTRUCTION WORK ZONES. THE CONTRACTOR SHALL BE SOLELY LIABLE FOR DAMAGE TO VEGETATION OUTSIDE CONSTRUCTION WORK ZONES AND SHALL RESTORE AT NO COST TO THE CITY ANY AREAS THAT ARE DAMAGED INCLUDING AREAS WITHIN THE LIMITS OF CONSTRUCTION OR ON ADJACENT PROPERTIES USING, TO THE EXTENT PRACTICABLE, THE SAME TYPES AND SIZES OF PLANT MATERIAL THAT EXISTED PRIOR TO CONSTRUCTION.
- 24. THE LOCATION AND CONSTRUCTION OF MAILBOXES SHALL BE IN CONFORMANCE WITH THE RULES AND REGULATIONS OF THE UNITED STATES POSTAL SERVICE. WHEN A MAILBOX IN CONFLICT WITH CONSTRUCTION IS REMOVED. THE CONTRACTOR SHALL FURNISH AND INSTALL A TEMPORARY MAILBOX AND SHALL MAINTAIN THE TEMPORARY MAILBOX UNTIL A NEW MAILBOX IS INSTALLED. THE CONTRACTOR SHALL CONSTRUCT A NEW MAILBOX TO MATCH, AS CLOSE AS PRACTICABLE, THE LOCATION, TYPE, SIZE, MATERIAL, AND COLOR OF THE ORIGINAL MAILBOX. IN LIEU OF CONSTRUCTING A NEW MAILBOX. THE EXISTING MAILBOX MAY BE REUSED IF IT MEETS THE RULES AND REGULATIONS OF THE UNITED STATES POSTAL SERVICE AND IS FUNCTIONALLY SOUND.
- 25. DISTURBED AREAS SHALL BE COMPACTED (AT A MINIMUM) EQUAL TO ADJACENT UNDISTURBED GROUND EXCEPT WHEN OTHERWISE SPECIFIED.
- 26. PROPERTIES ADJACENT TO WORK ZONES SHALL BE GRADED TO DRAIN WITHIN THE LIMITS OF CONSTRUCTION.
- 27. ALL DISTURBED AREAS WITHIN CONSTRUCTION WORK ZONES ARE TO BE GRASSED EXCEPT FOR AREAS THAT ARE LANDSCAPED, PAVED, OR BELOW NORMAL WATER LEVEL. EXISTING GRASSED AREAS SHALL BE REPLANTED WITH SOD OF THE SAME GRASS TYPE AS EXISTING, UNLESS OTHERWISE SHOWN ON THE PLANS OR DIRECTED BY THE ENGINEER. CENTIPEDE SOD WILL BE USED FOR DISTURBED AREAS NOT CURRENTLY GRASSED. REINFORCEMENT MAT SHALL BE INSTALLED BENEATH SOD PLACED ON SLOPES OF 2H:1V OR STEEPER, AND THE SOD SHALL BE STAPLED. COSTS FOR REINFORCEMENT MAT, STAPLING, FERTILIZING, AND WATERING SHALL BE INCLUDED IN THE UNIT PRICE OF THE PAY ITEM FOR PERFORMANCE TURE.
- 28. PRIOR TO REQUESTING A FINAL INSPECTION, THE CONTRACTOR SHALL PREPARE AND SUBMIT TO THE ENGINEER FOUR COMPLETE SETS OF CERTIFIED AS-BUILT RECORD DRAWINGS AND TWO COPIES OF THE DIGITAL FILES ON CD-ROM DISKS.

SUPPLEMENTAL GENERAL NOTES:

- CITY OF TALLAHASSEE SURVEYING PROVIDED THE TOPOGRAPHY, 1. BENCHMARKS, RIGHTS-OF-WAY AND UTILITY LOCATION INFORMATION SHOWN ON THE CONSTRUCTION DRAWINGS. ELEVATIONS ARE BASED ON NORTH AMERICAN VERTICAL DATUM OF 1988 (NAVD 88).
- THE CONTRACTOR SHALL PROTECT AND MAINTAIN ALL VALVE BOXES ON 2. GAS AND WATER MAINS WITHIN THE LIMITS OF CONSTRUCTION THAT ARE TO REMAIN IN SERVICE. PRIOR TO COMPLETION OF CONSTRUCTION, THE CONTRACTOR SHALL ADJUST ALL VALVE BOXES WITHIN CONSTRUCTION AREAS SO THE TOPS ARE FLUSH WITH FINISHED PAVEMENT OR WITH FINISHED GRADE IN UNPAVED AREAS.
- 3. ALL PUMPS USED FOR DEWATERING AND BYPASS PUMPING WILL BE SCREENED FROM RESIDENTIAL VIEW AND ENCLOSED TO REDUCE NOISE DURING OPERATION. AT NO TIME SHALL PUMPS BE PLACED WITHIN A RESIDENTIAL YARD OR 50 FEET OF A HOME WITHOUT APPROVAL FROM THE CITY. PAYMENT FOR SCREENING AND ENCLOSURE SHALL BE INCLUDED IN THE COST FOR CLEARING AND GRUBBING.

SUPPLEMENTAL GENERAL NOTES - STORMWATER CONSTRUCTION:

ALL NEW OR REPLACEMENT STORM DRAINS OR CULVERTS SHALL BE 1. CLASS III STEEL REINFORCED CONCRETE PIPE IN ACCORDANCE WITH STANDARD SPECIFICATION 449-4 OR FDOT APPROVED POLYPROPYLENE PIPE UNLESS NOTED OTHERWISE ON THE DRAWINGS. WHEN THE PLANS DESIGNATE A TYPE OF PIPE. THE CONTRACTOR MAY USE ONLY THE TYPE DESIGNATED. THE CONTRACTOR SHALL NOT USE A TYPE OF PIPE NOT

"NOTCHI ACCOMN INSTALLE CONFLIC 10. THE CON EXISTING OWNER-CONSTRU

7. ALL TYPE

8. ALL GRAT

2.

3.

4.

5.

6.

DESIGNATED ON THE DRAWINGS WITHOUT WRITTEN APPROVAL FROM THE ENGINEER. ALL PIPES SHALL BE CUT FLUSH WITH INSIDE OF DRAINAGE STRUCTURE.	ENGINEER OF RECORD LARE FLUCIS, FLUCIS, FL Elder, Mic. 2222 Rangbor Gene. Cicle State 222 Pathe 223 P.E. No. 5339 P.E. No. 5339 P.E. No. 5339 P.E. No. 5339
ALL REINFORCED CONCRETE PIPE SHALL BE INSTALLED USING SELECT BEDDING MATERIAL TO PROVIDE A FOUR-INCH MINIMUM DEPTH FOUNDATION BENEATH THE BARREL OF THE PIPE AND FOR BACKFILL UP TO THE SPRINGLINE (CENTER) OF THE PIPE. BACKFILL AROUND POLYPROPYLENE PIPE SHALL BE IN ACCORDANCE WITH THE MANUFACTURER'S SPECIFICATIONS.	ENGINE LANE 2822 Ren Talaharan P.E.
ALL JOINTS OF CONCRETE PIPES, CULVERTS, AND STORM SEWERS SHALL HAVE A FILTER FABRIC JACKET AS DETAILED ON STANDARD INDEX NO. 280, UNLESS NOTED OTHERWISE ON THE DRAWINGS OR DIRECTED BY THE ENGINEER.	
ALL PIPE CULVERTS AND STORM SEWERS 48-INCHES OR LESS IN DIAMETER SHALL BE VIDEO TAPED IN ACCORDANCE WITH SECTION 430-4.8 OF THE STANDARD SPECIFICATIONS UNLESS OTHERWISE DIRECTED BY THE ENGINEER.	
ALL CURB INLETS, DITCH BOTTOM INLETS, AND MANHOLES SHALL HAVE TRAFFIC BEARING FRAMES AND COVERS OR GRATES MEETING HS-20 LOADING REQUIREMENTS UNLESS OTHERWISE SHOWN ON THE PLANS.	ä
ALL STORM DRAIN COVERS SHALL BE TYPE USF TJ (U.S. FOUNDRY NO. 8017195), NPR15-728 (EJ GROUP COVER NO. 3062A2), OR APPROVED EQUAL.	ORIGINAL REVISIONS: 1 2 3 5
ALL TYPE J STRUCTURE BOTTOMS SHALL HAVE A MINIMUM 6'-0" WALL HEIGHT WHEN POSSIBLE.	
ALL GRATES SHALL BE CHAINED AND LOCKED IN ACCORDANCE WITH STANDARD INDEX NO. 201. COST OF EYEBOLTS AND CHAIN SHALL BE INCLUDED IN THE CONTRACT UNIT PRICE FOR THE STRUCTURES.	NOTES
UTILITIES IN CONFLICT WITH THE INSTALLATION OF A NEW STORM DRAIN ARE TO BE ADJUSTED OR RELOCATED TO ELIMINATE THE CONFLICT. IF THE CONFLICT CANNOT BE REASONABLY AVOIDED, A CONFLICT STRUCTURE WITH ACCESS SHALL BE CONSTRUCTED IN ACCORDANCE WITH STANDARD INDEX NO. 307 WITH THE EXCEPTION THAT FOR UTILITY CONFLICT CONDITION II (PRESSURE OR FLUID CARRIER INSTALLATIONS), A CARRIER PIPE IS NOT REQUIRED IF DUCTILE IRON PIPE IS USED FOR THE UTILITY AND NO PIPE JOINTS ARE LOCATED WITHIN THE CONFLICT STRUCTURE.	GENERAL
"NOTCHING" OF A STORM DRAIN PIPE OR STRUCTURE TO ACCOMMODATE A UTILITY SHALL NOT BE ALLOWED. NO UTILITY SHALL BE INSTALLED THROUGH ANY PORTION OF A STORM DRAIN PIPE WITHOUT A CONFLICT STRUCTURE.	N PARK EMENTS
THE CONTRACTOR SHALL EXCERCISE CAUTION WHILE REMOVING EXISTING LANDSCAPING, FENCES, DECORATIVE WALLS, AND OTHER OWNER-INSTALLED IMPROVEMENTS WITHIN THE LMITS OF CONSTRUCTION. THE CONTRACTOR SHALL STOCKPILE THE REMOVED MATERIALS IN A NEAT AND ORDERLY MANNER AT A LOCATION AGREEABLE TO THE PROPERTY OWNER.	PROJECT BRECKENRIDGE ON DRAINAGE IMPROV
	Engineering (Lithites, Transportation, and Water 2822 Remington Green Cit., Suite 202 PHONE. (850) 383-0400 TALLAHASEE, FLORIDA 32308 WWW-entawine.com Certificate of Authorization #9961
	DRAWN DESIGNED CHECKED QC

GENERAL PAY ITEM NOTES:

- 1. NO SEPARATE PAYMENT WILL BE MADE FOR DEWATERING. THE COSTS FOR DEWATERING SHALL BE INCLUDED IN THE UNIT PRICES FOR ANY ITEMS REQUIRING DEWATERING.
- 2. NO SEPARATE PAYMENT WILL BE MADE FOR FILTER FABRIC. THE COSTS FOR FILTER FABRIC SHALL BE INCLUDED IN THE UNIT PRICES FOR ANY ITEMS REQUIRING FILTER FABRIC.
- 3. NO SEPARATE PAYMENT WILL BE MADE FOR VIDEO TAPING PIPE CULVERTS. THE COSTS FOR VIDEO TAPING ARE INCLUDED IN THE UNIT PRICES FOR PIPE CULVERT.
- 4. ADDITIONAL QUANTITIES OF EROSION CONTROL AND/OR TREE PROTECTION ITEMS MAY BE NECESSARY AS DETERMINED DURING CONSTRUCTION BY THE CONTRACTOR, THE ENVIRONMENTAL INSPECTOR, OR BY THE ENGINEER AND MUST BE APPROVED BY THE ENGINEER.
- 5. UNIT PRICES FOR PIPES, CULVERTS, SEWER PIPE AND WATER MAIN INCLUDE THE COSTS FOR FURNISHING, INSTALLING, MAINTAINING AND REMOVAL OF 1.5 INCH MINIMUM THICKNESS OF ASPHALT PAVEMENT MILLINGS OR FINE TYPE SP ASPHALTIC CONCRETE AT THE GROUND SURFACE OF ALL PIPE AND BOX CULVERT TRENCHES IN PAVED AREAS FOR THE PURPOSE OF SEDIMENT AND EROSION CONTROL UNTIL THE FINAL PAVEMENT IS PLACED.

STORMWATER PAY ITEM NOTES:

101-1: MOBILIZATION

THE UNIT PRICE ALSO INCLUDES ALL COSTS FOR PREPARATION OF AN APPROVED CONSTRUCTION PROGRESS SCHEDULE, AN APPROVED EROSION CONTROL PLAN, AN APPROVED TRAFFIC CONTROL PLAN, AN APPROVED DEWATERING PLAN, THE PRECONSTRUCTION SURVEY, PREPARING AND SUBMITTING APPROVED SHOP DRAWINGS, AND FURNISHING, INSTALLING, AND REMOVING THE PROJECT SIGNS. THE UNIT PRICE ALSO INCLUDES THE COST OF ARBORIST MITIGATION AS DETAILED IN THE PLANS (SEE TREE PROTECTION AND EROSION CONTROL SHEETS)

102-1: MAINTENANCE OF TRAFFIC

THE UNIT PRICE CONSTITUTES FULL COMPENSATION FOR ALL LABOR AND MATERIALS REQUIRED TO IMPLEMENT THE APPROVED TRAFFIC CONTROL PLAN TO SAFELY MAINTAIN TRAFFIC AROUND OR THROUGH THE WORK ZONE NOT INCLUDED FOR PAYMENT UNDER OTHER RELATED PAY ITEMS, INCLUDING WARNING AND REGULATORY SIGNS, MESSAGE BOARDS, DRUMS, BARRICADES, CHANNELIZING DEVICES, TEMPORARY CONCRETE BARRIER, WARNING LIGHTS, FLAGGERS, BUSINESS ENTRANCE SIGNS, MAINTENANCE OF EXISTING DRIVEWAYS, TEMPORARY PAVEMENT, AND REMOVAL AND REINSTALLATION OF EXISTING SIGNS IN CONFLICT WITH CONSTRUCTION AS DIRECTED BY THE ENGINEER. NO ADJUSTMENTS WILL BE MADE TO THE CONTRACT PRICE FOR INCREASES IN CONTRACT TIME. THE UNIT PRICE ALSO INCLUDES THE COST OF WET WEATHER DRIVING SURFACES FOR THE DURATION OF THE PROJECT AND DUST CONTROL AS NEEDED AT ALL OTHER TIMES.

102-70: TEMPORARY BARRICADE FENCE (ORANGE) THE UNIT PRICE CONSTITUTES FULL COMPENSATION FOR ALL LABOR AND MATERIALS NECESSARY FOR THE INSTALLATION, MAINTENANCE, AND REMOVAL OF TEMPORARY BARRICADE FENCE. THIS ITEM IS TO BE USED FOR PEDESTRIAN SAFETY, TREE PROTECTION, OR AS DIRECTED BY THE ENGINEER.

104-14: STORMWATER POLLUTION PREVENTION

THE UNIT PRICE CONSTITUTES FULL COMPENSATION FOR ALL LABOR AND MATERIALS NECESSARY FOR THE INSTALLATION AND MAINTENANCE OF EROSION AND SEDIMENT CONTROL DEVICES AS REQUIRED TO PREVENT THE OFF-SITE TRANSPORT OF SEDIMENT. INCLUDING SEDIMENT BARRIERS, SEDIMENT BASINS, AND CONTAINMENT SYSTEMS AS SHOWN ON THE PLANS AND/OR DESCRIBED IN THE STATE OF FLORIDA EROSION AND SEDIMENT CONTROL DESIGNER AND REVIEWER MANUAL. THE PRICE ALSO INCLUDES THE PERIODIC REMOVAL AND DISPOSAL OF ACCUMULATED SEDIMENT, AND REMOVAL AND DISPOSAL OFF-SITE OF EROSION AND SEDIMENT CONTROL MATERIALS, INCLUDING ROCK AND RUBBLE RIPRAP. AT COMPLETION OF CONSTRUCTION. FURNISHING AND PLACING SUITABLE MATERIAL AS REQUIRED TO FILL SEDIMENT SUMPS, ANY PERMITS AND FEES REQUIRED FOR OFF-SITE DISPOSAL, AND TURBIDITY MONITORING IN COMPLIANCE WITH THE ENVIRONMENTAL PERMITS.

110-1-1: CLEARING AND GRUBBING

THE UNIT PRICE ALSO INCLUDES REMOVAL AND DISPOSAL OF TREES, ASPHALT, BASE, SUB-BASE, CURBS, SIDEWALKS, DRIVEWAYS, DRAINAGE STRUCTURES, PIPES, FENCES, SANITARY SEWER PIPES & STRUCTURES, AND ALL OTHER STRUCTURES AND OBSTRUCTIONS NECESSARY TO BE REMOVED AND FOR WHICH OTHER ITEMS OF THE CONTRACT DO NOT SPECIFY THE REMOVAL THEREOF. PARTIAL PAYMENTS WILL BE BASED UPON THE ESTIMATED TOTAL VALUE OF WORK COMPLETED TO THE DATE OF THE ESTIMATE AS DETERMINED BY THE ENGINEER. ALL PARTIAL ESTIMATES AND PAYMENTS ARE SUBJECT TO CORRECTION IN SUBSEQUENT ESTIMATES AND PAYMENT. THE UNIT PRICE ALSO INCLUDES ALL COSTS FOR REMOVAL OF EXISTING FENCES AND RELOCATION OR REPLACEMENT WITH NEW FENCE OR WITH THE FENCING MATERIAL THAT WAS REMOVED IF IT IS UNDAMAGED, AND FOR THE RELOCATION OR REPLACEMENT OF MAILBOXES.

110-7-1: MAILBOX:

UNIT PRICE SHALL INCLUDE ALL COSTS TO MEET THE REQUIREMENTS OF THE GENERAL NOTES ON SHEET 3 (GENERAL NOTE 24) OF THE PLANS.

120-1 AND 120-6: REGULAR EXCAVATION AND EMBANKMENT FINAL PAY QUANTITY WILL BE PLAN QUANTITY WITH NO CONSIDERATION FOR SPECIFICATION TOLERANCES. THE UNIT PRICE ALSO INCLUDES ALL COSTS FOR TURBIDITY MONITORING IN COMPLIANCE WITH THE ENVIRONMENTAL PERMITS.

334-1-12: SUPERPAVE ASPHALTIC CONCRETE (2" THICK) THE UNIT PRICE SHALL INCLUDE THE ADJUSTMENT OF ALL EXISTING UTILITY FRAMES AND COVERS AND WALL WATER AND GAS VALVES WITHIN THE LIMITS OF CONSTRUCTION.

425-1-521, 425-1-523, 425-1-541 425-1-553: DITCH BOTTOM INLETS UNLESS OTHERWISE NOTED IN THE PLANS, THE UNIT PRICES ALSO INCLUDE ALL COSTS FOR FURNISHING AND INSTALLING TRAFFIC BEARING GRATES MEETING HS-20 LOADING REQUIREMENTS. THE UNIT PRICES FOR DITCH BOTTOM INLETS WITH SLOTS ALSO INCLUDE ALL COSTS FOR FURNISHING AND INSTALLING 1 INCH DIAMETER POWDER COATED STEEL BARS CAST INTO THE STRUCTURES AS SHOWN IN THE PLANS. THE UNIT PRICE SHALL ALSO INCLUDE THE COST OF ALL MODIFIED TRAVERSABLE AND MODIFIED NON-TRAVERSABLE SLOTS.


425-2-61, 426-2-71, 425-2-91: MANHOLES AND JUNCTION BOXES UNLESS OTHERWISE NOTED IN THE PLANS, THE UNIT PRICES ALSO INCLUDE ALL COSTS FOR FURNISHING AND INSTALLING TWO-PIECE COVERS AND FRAMES WITH 3'-0" OPENINGS WHEN THE DEPTH OF THE STRUCTURE EXCEEDS 6'-0".


430-175-118, -124, -136, -148, -230: PIPE CULVERT, CONCRETE THE UNIT PRICES ALSO INCLUDE PAYMENT FOR SHEETING AND/OR SHORING, DEWATERING, FILTER FABRIC, FURNISHING, PLACING AND COMPACTING SELECT BEDDING MATERIAL, AND FURNISHING SELECT MATERIAL FOR BACKFILL WHEN SUITABLE MATERIAL IS NOT AVAILABLE ON SITE. UNIT PRICE ALSO INCLUDES THE COSTS OF REPLACEMENT OF ADJOINING FENCES IMPACTED BY CONSTRUCTION ACTIVITIES. CONTRACTOR SHALL COORDINATE WITH CITY ELECTRIC DEPARTMENT, CITY GAS DEPARTMENT, CITY WATER & SEWER DEPARTMENT, COMCAST CABLE, AND CENTURY LINK COMMUNICATIONS IN THE PROTECTION AND/OR RELOCATION OF THEIR FACILIITES. ALL COSTS ASSOCIATED WITH THESE REQUIREMENTS SHALL BE INCLUDED IN THE UNIT PRICE.


522-2: CONCRETE DRIVEWAY RECONSTRUCTION THE UNIT PRICES CONSTITUTES FULL PAYMENT FOR REMOVAL OF EXISTING CONCRETE, EXCAVATION, GRADING, FURNISHING AND INSTALLING 6" CONCRETE PAVEMENT TO RESTORE CONCRETE DRIVEWAYS AT LOCATIONS SHOWN IN THE PLANS.


570-1-2: PERFORMANCE TURF, SOD, CENTIPEDE AND ST. AUGUSTINE THE UNIT PRICES CONSTITUTE FULL COMPENSATION FOR ALL LABOR, MATERIALS, AND INCIDENTALS REQUIRED FOR ESTABLISHING A STAND OF GRASS BY SODDING IN ACCORDANCE WITH SECTION 570 OF THE STANDARD SPECIFICATIONS, INCLUDING FURNISHING AND PLACING SOD, PEGGING WHEN SPECIFIED IN THE PLANS, AND FURNISHING AND APPLYING FERTILIZER AND WATER. THE UNIT PRICES ALSO INCLUDE AND MAINTENANCE, INCLUDING LITTER REMOVAL AND MOWING UNTIL FINAL ACCEPTANCE.

ENGINEER OF RECORD LANE P. LUCAS, P.E. Eutaw, Inc.	2822 Reminipator Green Circle Sulte 20 Tallahresee, FL 32008 P.E. NO, 53936	Signature Date
ORIGINAL	0 0 7	
SHEET	PAY ITEM NOTES	
PROJECT	BRECKENRIDGE ON PARK DRAINAGE IMPROVEMENTS	
Eutow, INC	Engineering Utilities, Transportation, and Water 2822 Remington Green Cir., Suite 202 PHONE. (850) 383-0400 TALLAMASEE, FLORDA 22308 WWW.eutrawine.com Certificate of Authorization #9961	
JOB N DRAWN DESIGN CHECK QC	I	

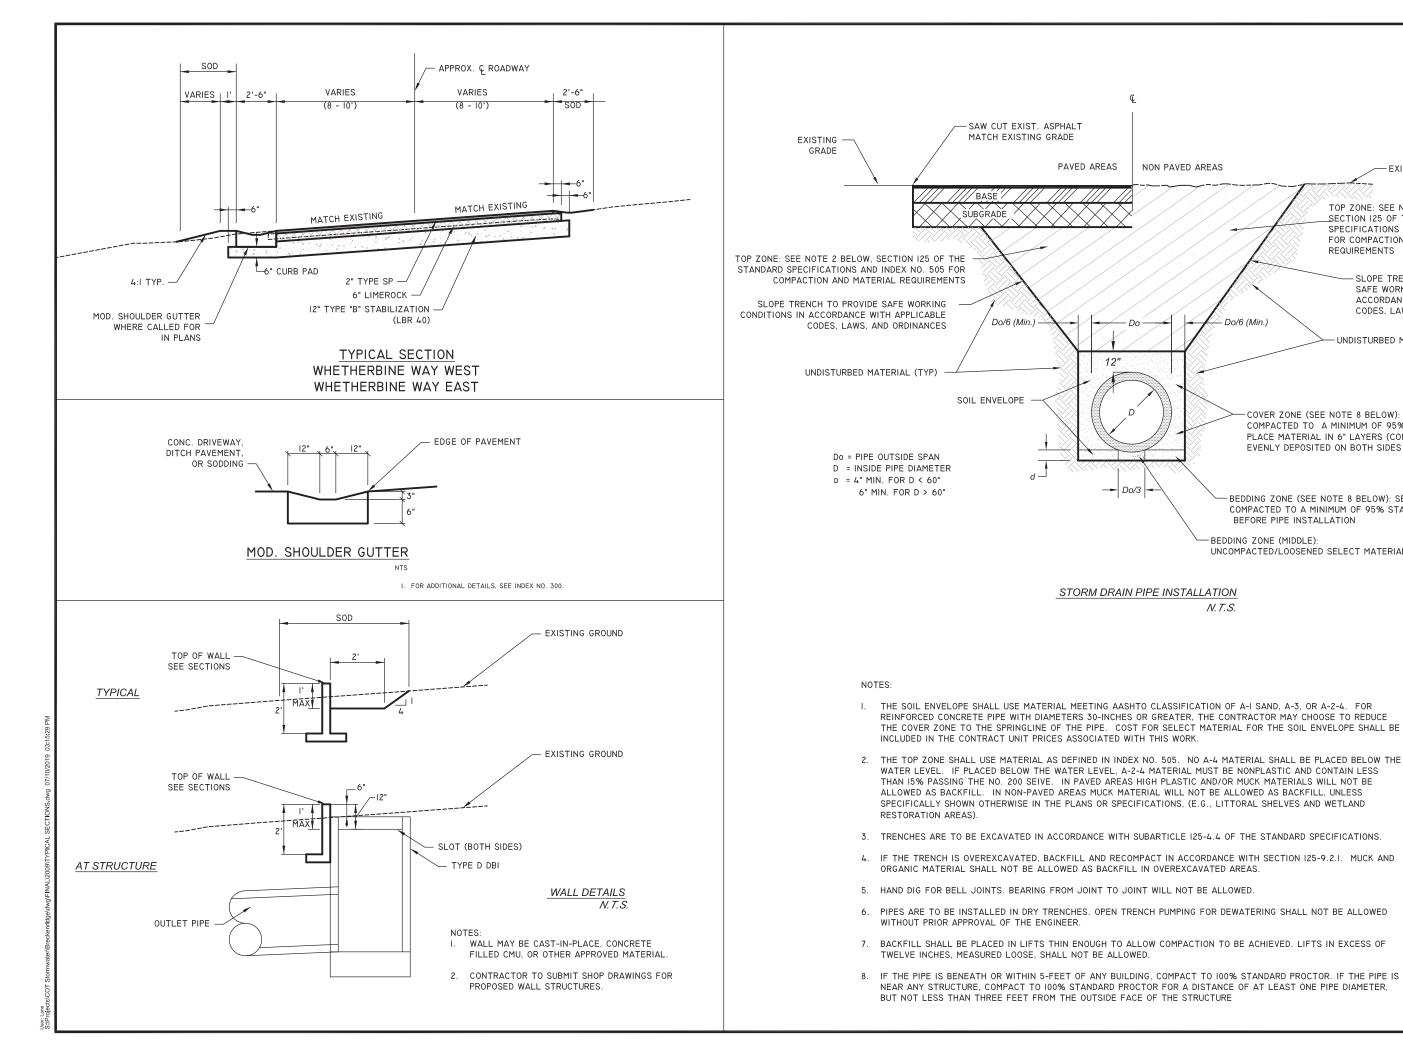


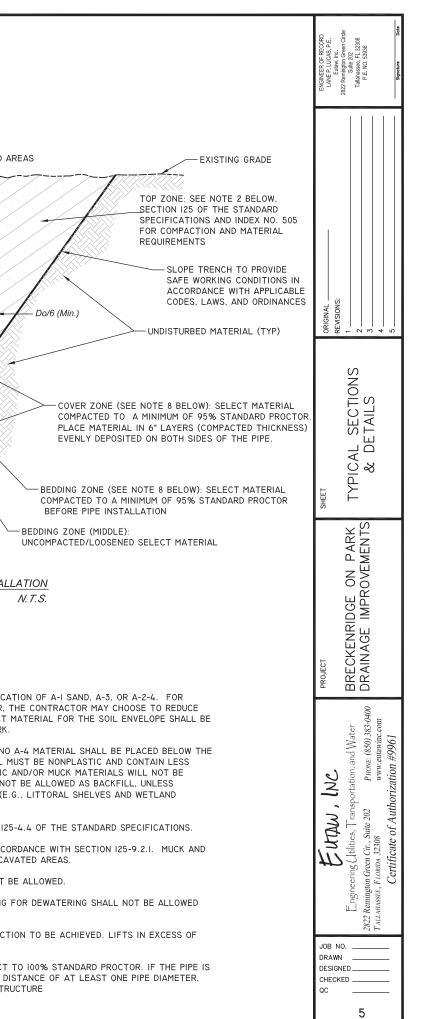


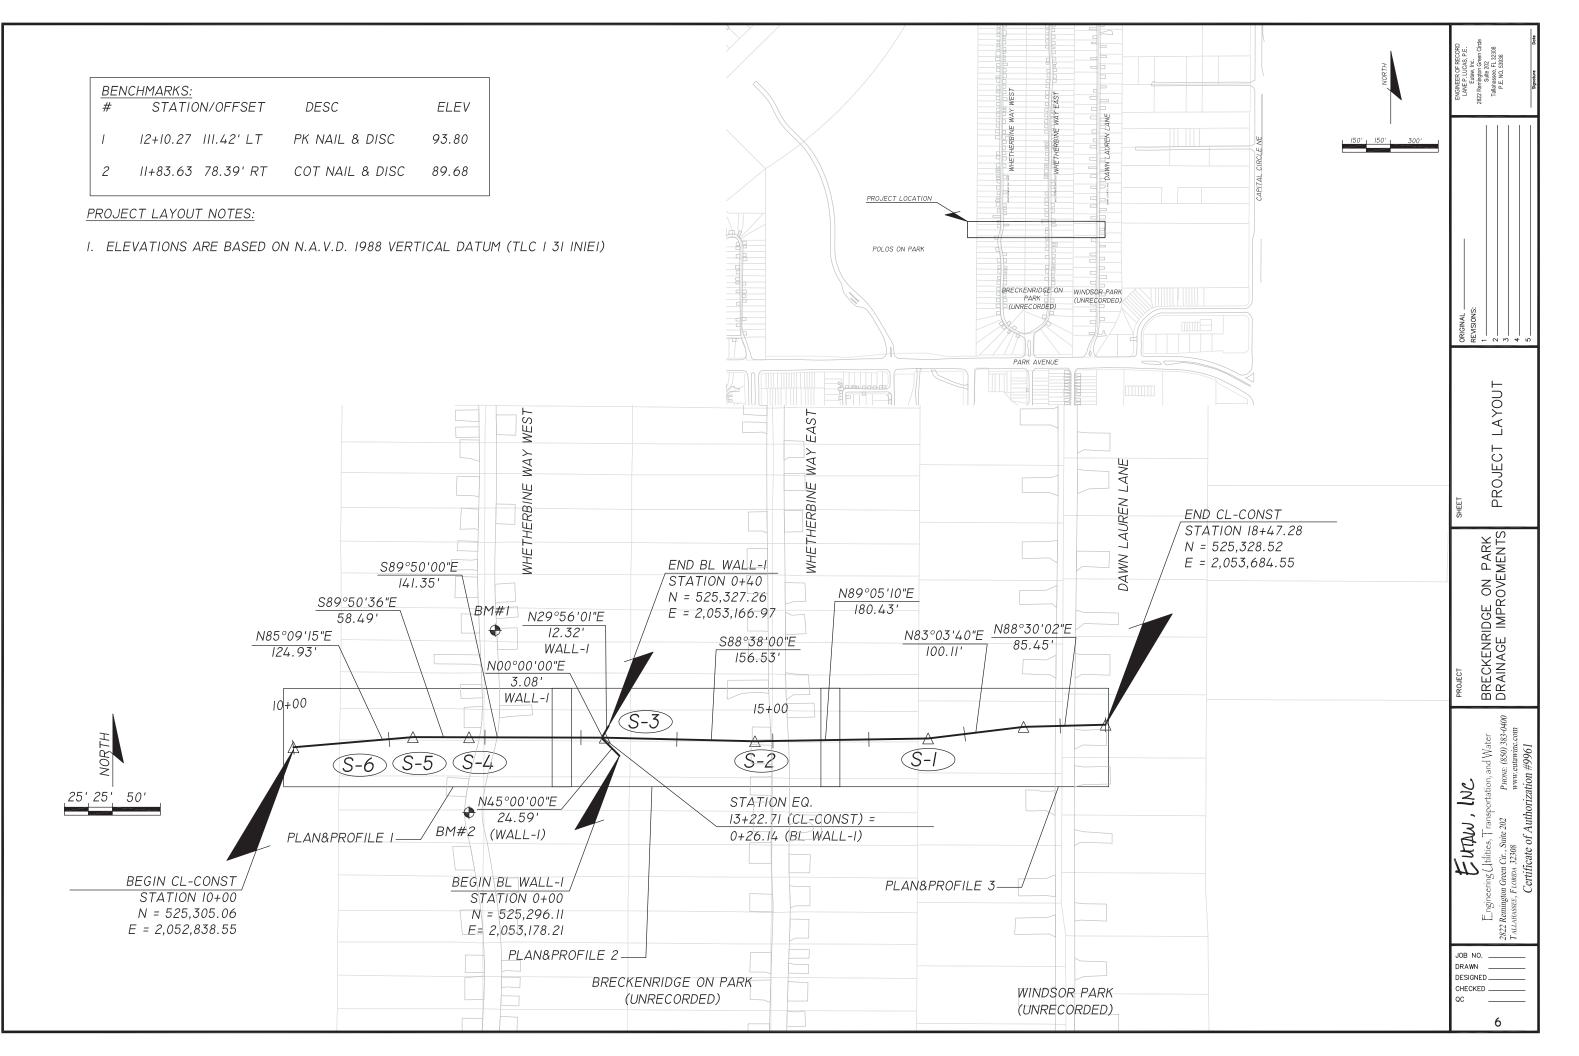

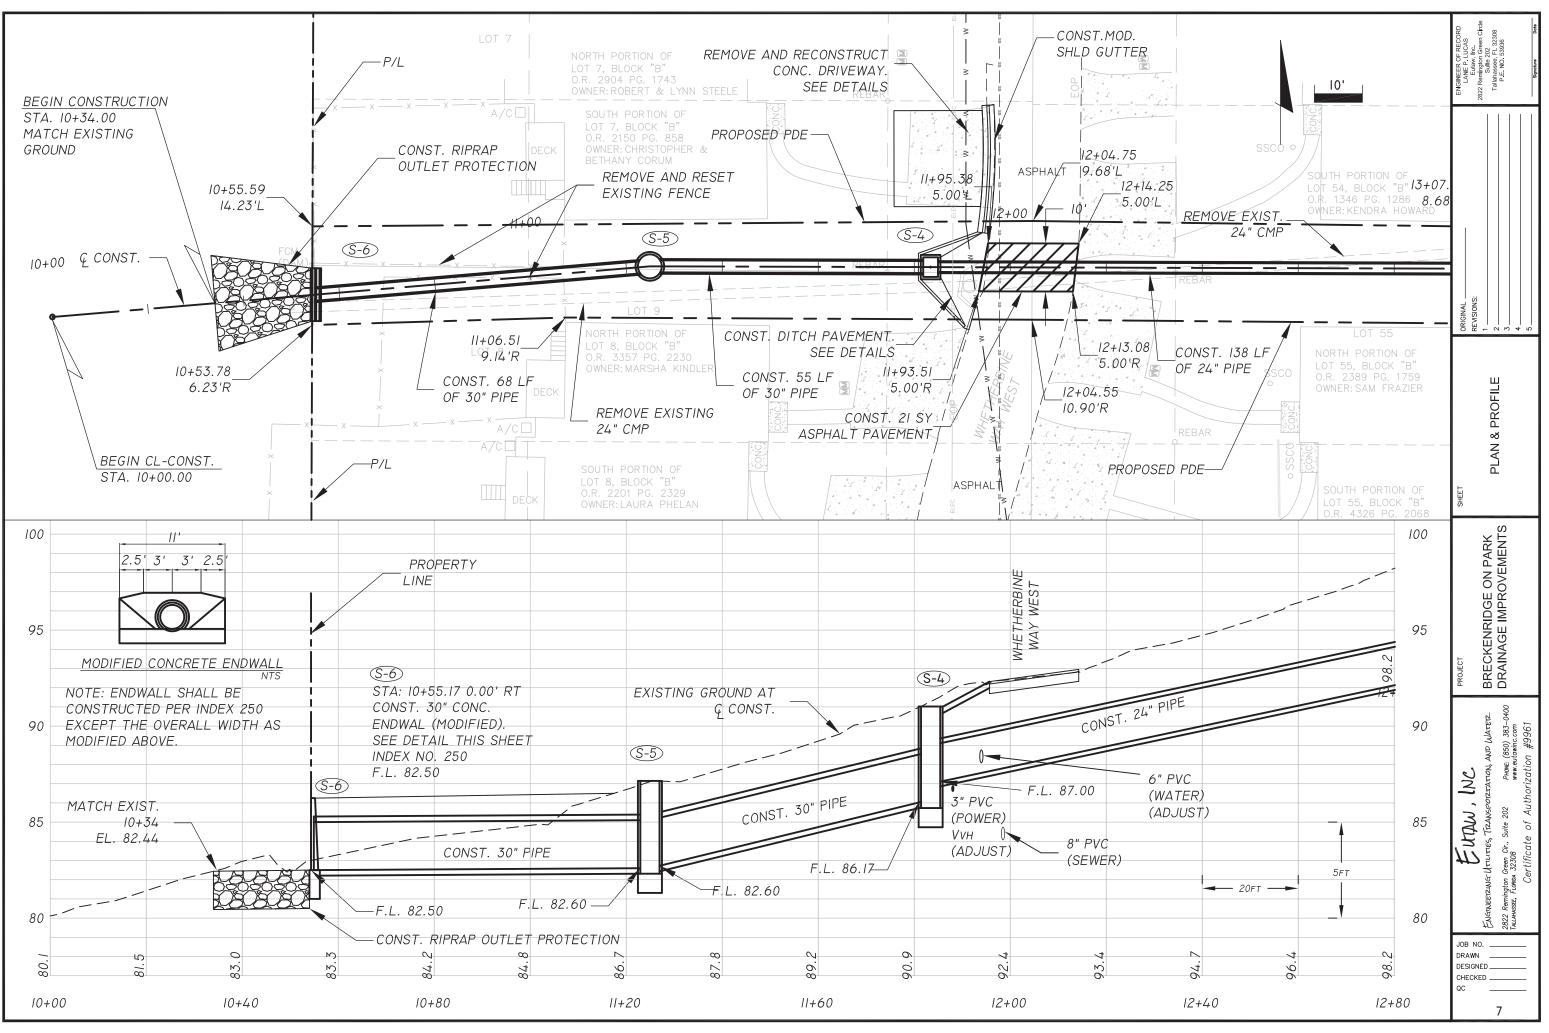

^{ne} jects\COT Stormwater\Breckenrldge\dwg\FINAL\2018\BR-Plan&Profile.dwg 07/11/2019 (

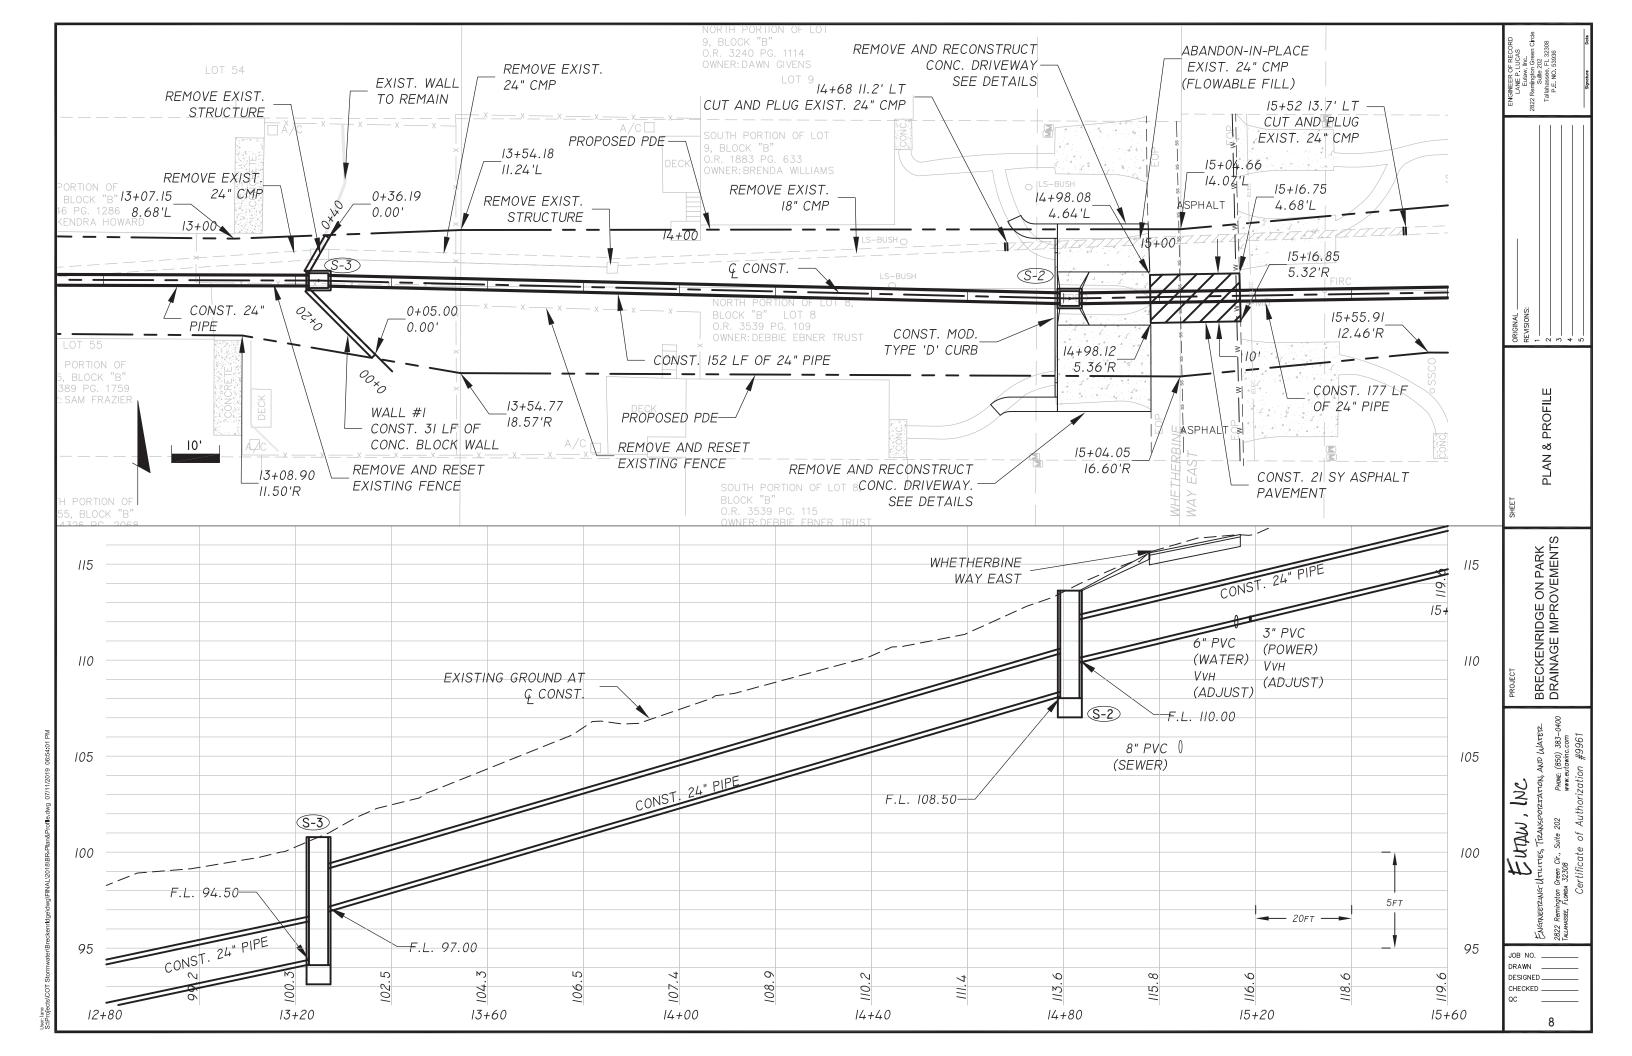


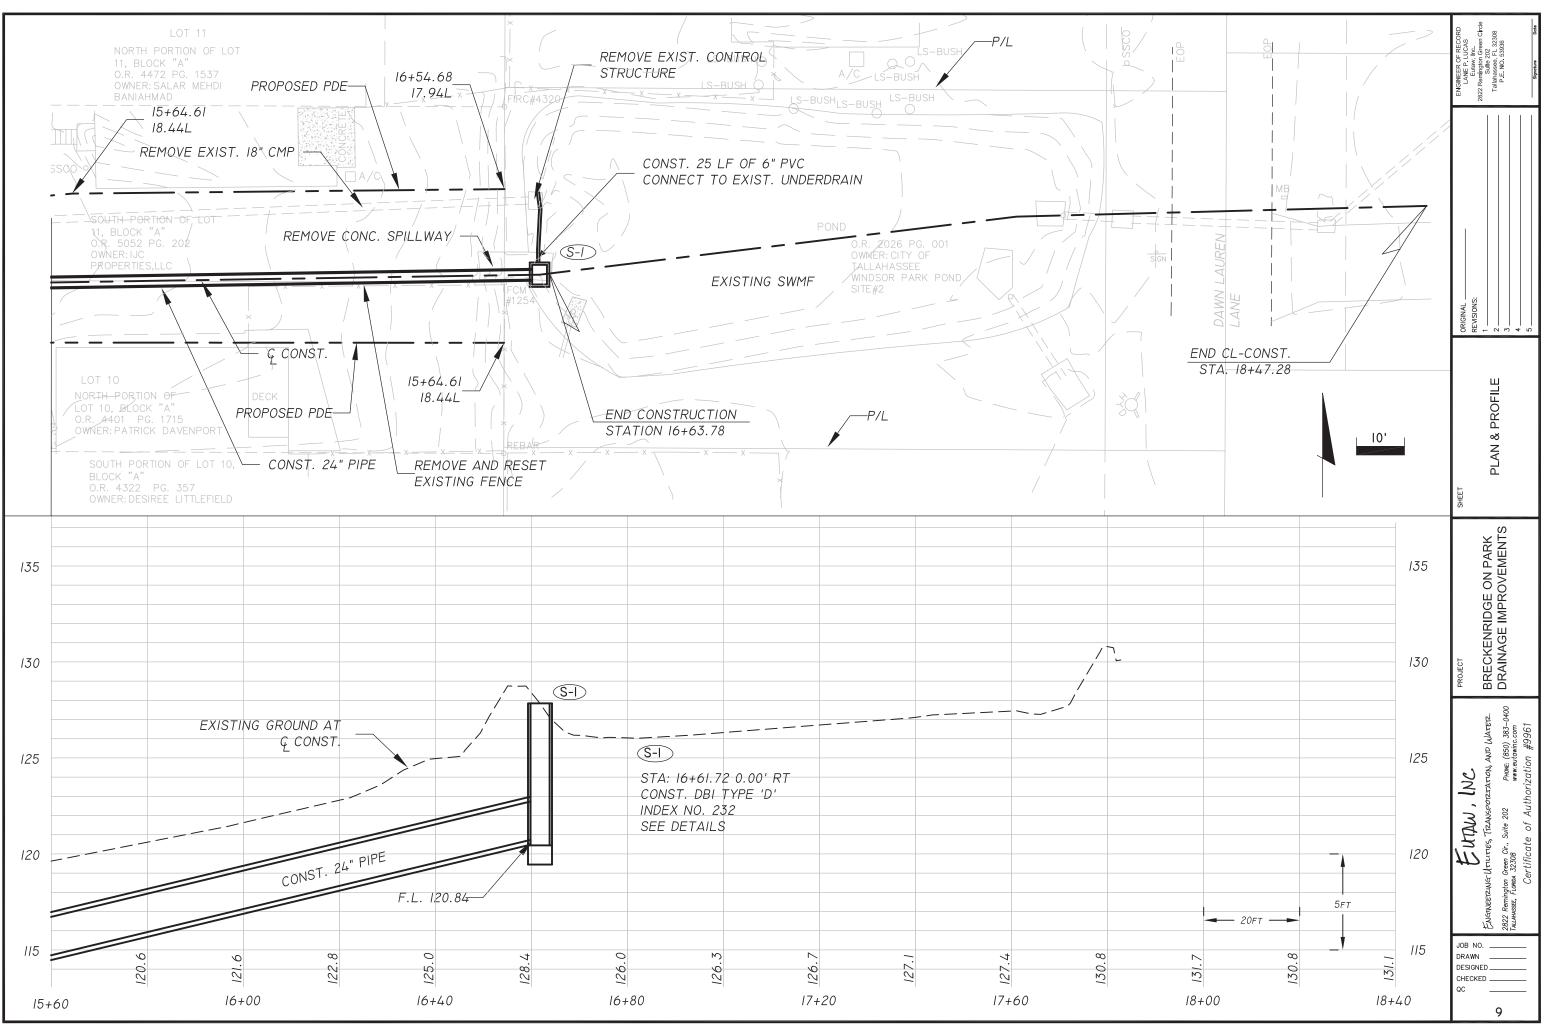


scts\COT Stormwater\Breckenrtige\dwg\FINAL\2018\BR-Plan&Profile.dwg 07/11/2019 0

						. 01. 20	
<u>(S-4)</u>	+8	83.41			14-1	+81.29	
STA: 11+83.41 0.00	'RT FRA						
CONST. DBI TYPE	'D' FROM	1 <u>S-3</u>			FRC	DM S-I	
WITH SLOT		+					
INDEX NO. 232		Μ N		§-2		9	
GRATE: 91.00		24" PIPE		STA: 14+81.29 0.00' F	?T	24" PIPE	
SLOT: 90.50 (AH)				CONST. DBI TYPE 'D'			
F.L. 87.00 (AH)			_	WITH SLOT			
F.L. 86.17 (BK) ₉₀			90	INDEX NO. 232 -			
				GRATE: 113.62			
86		M	86	SLOT: 113.04 (LT, RT)	110	110	
	^			F.L. 110.00 (AH) F.L. 108.50 (BK)		CONCRE SEE DET	TE DITCH PAVEMENT,
82	L		82	F.L. 100.30 (BK)	106	106	
		30" PIPE					
		JU FIPE					
						24" PIPE	
		Ы				bJ	
	ТС) (\$-5)			T	0 (\$-3)	
	-20 -10	0 10	20		-20 -10	0 10 20	
			40				
	11.0						
	+2	24.93					
					13.	24.76	
C E	FRO	1 (S-4)			13+	24.70	
S-5				<u>\$-3</u>			
STA: 11+24.93 0.00		m l			FRC)M (S-2)	
CONST. MH TYPE J	-8 (5')			STA: 13+24.76 0.00' CONST. DBI TYPE 'L	RI		
INDEX NO. 200,201		30" PIPE		WITH SLOT			
RIM: 87.14				INDEX NO. 232		24" PIPE	
F.L. 82.60 (AH) 88			88	GRATE: 100.78	106	106	DRAINAGE STRUCT
F.L. 82.60 (BK)				SLOT: 100.28 (LT, R	T)		I. ALTHOUGH THE
84			84		102	102	DRAINAGE STRUCT AVAILABLE INFORM
				F.L. 94.50 (BK)			FIELD CONDITIONS
80			80		98	98	THE ELEVATIONS
							TOPS SHOULD BE
		30" PIPE			94	96	GROUND OR PAVEM
						24" PIPE	
	т.) (\$-6)					
					T	0 (\$-4)	
	-20 -10	0 10	20		-20 -10	0 10 20	20F
	-20 -10	0 10	– •				


						RD Circle Date
						ENGINEER OF RECORD LANK P. LUCKS Edlaw, Inc. 2822 Ranipolon Gerein Circle Jallehussee, FL 32308 P.E. NU. 53336 P.E. NU. 53336
						NEER OF ANE P. LI Eutaw, I emington Sulte 21 ahassee, F P E. NO. 5 Signeture
						IGINEI LAN E P.E. allaha Sor Sor
						2822 EN
						ORIGINAL _ 12 255
						ORIGINAL REVISIONS 2 3 4 5
						ŝ
						BRAINAGE STRUCTURES
						DEC
						RUC
						STI
						Щ
						AAC
						r all
						DR
						ie on Park Rovements
						1EN AR
						ŌŎ
						PROJECT BRECKENRIDGE ON PARK DRAINAGE IMPROVEMENT
						PROJECT BRECKENRIDG DRAINAGE IMP
						EN GE
						5 YS
						BREC
						- @□
						400
RE NO	DTES:					ATETE 883–0 2011 961
LEVA	TIONS	OF THE	TOPS (DF		150) JU 150) J 1499
RES 4	RE BAS	SED ON	THE BE	ST		EVENU, INC ENGRAVERERUGE UTULTES, TEANSPORTATION, AND WATER 2822 Remington Green Cir., Suite 202 PHONE: (850) 383-0400 TAUMASSEE, FLORED 32308 TAUMASSEE, FLORED 32308 Certificate of Authorization #9961
TION	, THEY	MAY NO	T MAT			PHG PHG PHG WWW
NLET		SHOULE		т то), orer thou
	ACENT		MANHC			ENGRNEETLANG-ULTU-TES, TIZANSP ENGENEETLANG-ULTU-TES, TIZANSP 2822 Remington Green Cir. Suite 202 TAULANSEE, FLOREN 32308 TAULANSEE, FLOREN 32308
			INISHEE)		suite Suite
NI E	LEVATIO	JNS.				to a cott
	T					-Ultru Green 3230 3rtifi
	1					ZUNG gton ⁻ Lorea
	10					rNEET Remin ssee, f
	IOFT					ENGT 2822 , ALAHA
						JOB NO
	l l					DRAWN
	-					DESIGNED CHECKED
						QC
						10
						10

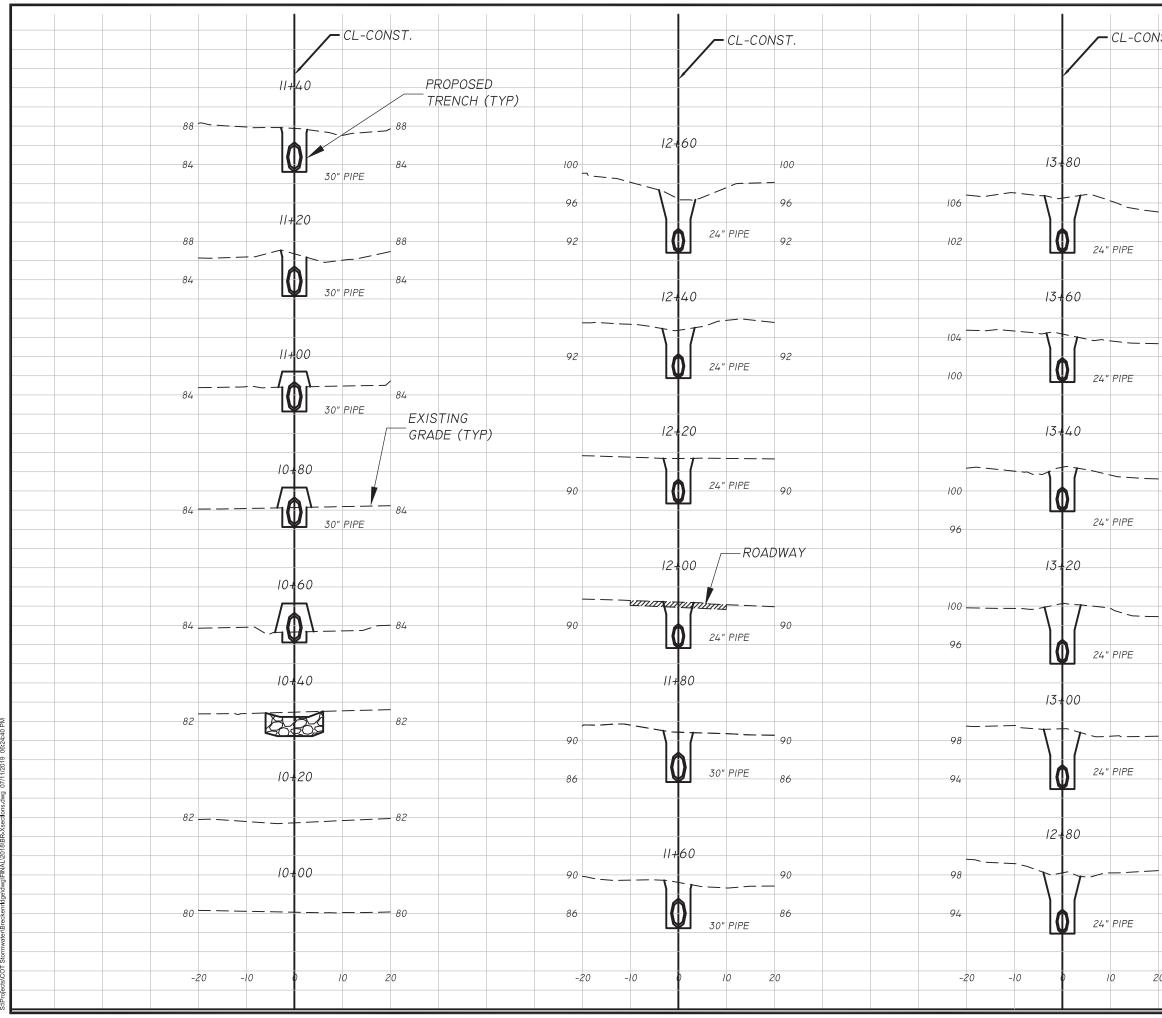


IST.	ENGINEER OF RECORD LANE P. LUCAS Eulaw, Inc. 2822 Remington Green Circle Tallahasses, FL 32308 P.E. NO. 53336 P.E. NO. 53336
106	
	ORIGINAL REVISIONS: 3 2 2 2 2 2 2 2 2 2 2 2 2 2 2 2 2 2 2 2
104 100 100 100 100 100	SHEET CROSS SECTIONS
96	PROJECT BRECKENRIDGE ON PARK DRAINAGE IMPROVEMENTS
98 94 94 98 94 94 98 98 98	Evenueraria Induction (1996) Evenueraria Francis Francis Incontration (1996) Evenueraria Signa Green Cir., Suite 202 Prover. (1850) Taurunsee, Fraena 3338 Taurunsee, Fraena 3338
94 10FT 20FT 0	↓15< ℜ,₹ JOB NO.

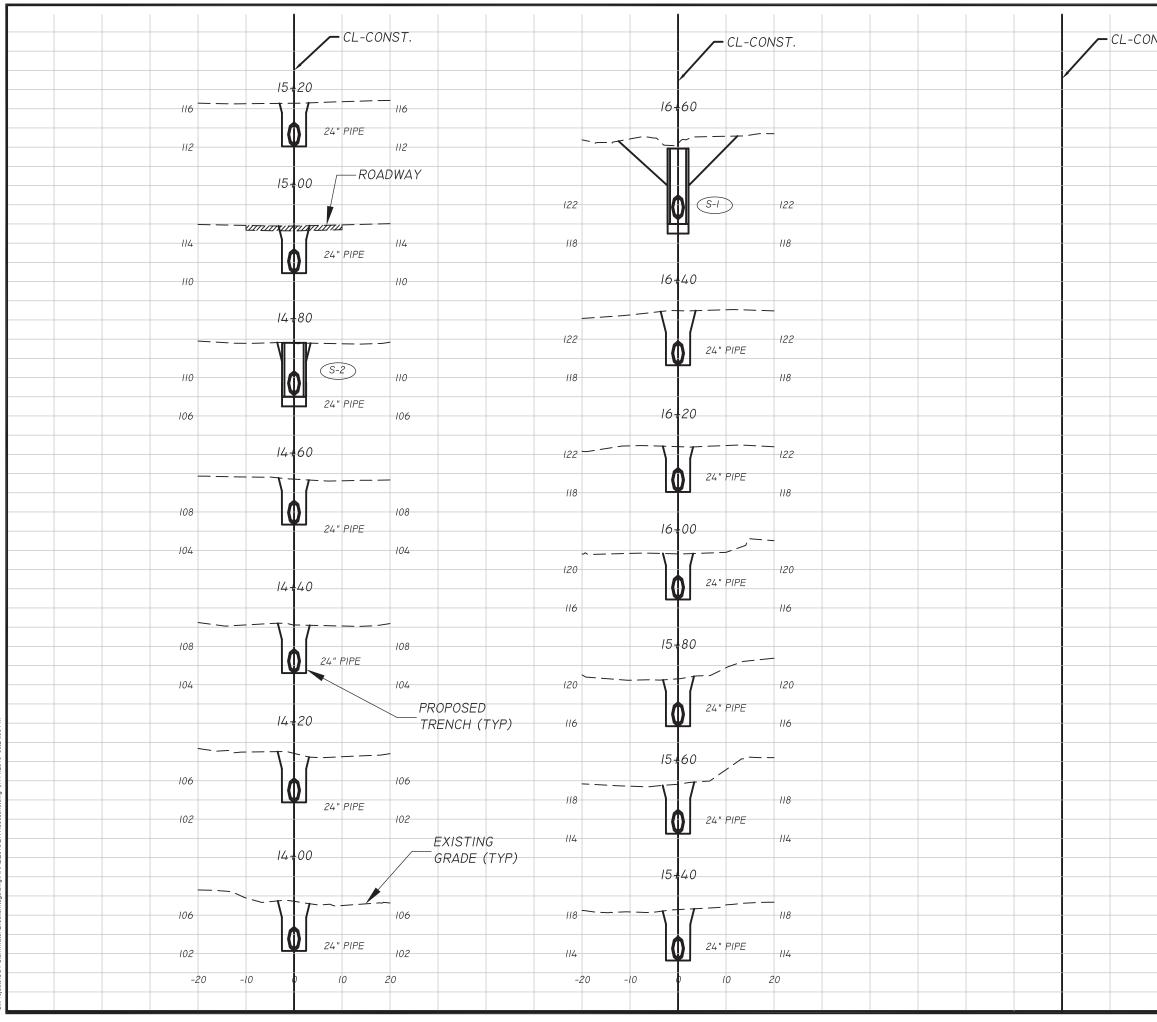

					DRD Crircle 308 bite
NST.					ENGINEER OF RECORD LARE P. LUCAS Eulaw Imc. 2822 Renidon Green Circle 7 allahassee, FL 32308 P.E. NO. 53936 Sepatwa Data
					NGINEER (LANE P. LANE P. Eutam 22 Remingto 22 Remingto 22 Remingto 22 Remingto 21 Remingto 29 P.E. NO 21 P.E. NO
					Г 583 Ш
					ι i i i i i i i i i i i i i i i i i i i
					ORIGINAL _ 12 35
					л Л П – С – С – С – С – С – С – С – С – С –
					CROSS SECTIONS
					CTIC
					UN CONTRACTOR
					SOS
					SHEET
					υ N
					ARK
					VEN P
					PROJECT BRECKENRIDGE ON PARK DRAINAGE IMPROVEMENTS
					AGE
					BRECH
					R H H
					-0400
					• Шант 0) 383- inc.com
					NC rton, and Water phone: (850) 383-0400 www.eutomin.com zation #9961
					PHC PHC
					NUU, NSPOR 202 Auth
					e of
_					EVERNEERLING UTAW, INC EVERNEERLING UTURES, TRANSPORZATION, AND WATER 2822 Remington Green Cir., Suite 202 PHONE. (850) 383-0401 TALUMASSE, FLANKA, SUITE 202 PHONE. (850) 383-0401 TALUMASSE, FLANKA, CERTIFICATE OF AUTHORIZATION #9961
			—		NG-Ut on Gree Served 32. Certi
			4		rNEE121 Remingt ssee, FLu
			IOFT		ENGA 2822 H TALLAHAI
					JOB NO DRAWN
	20	FT 			DESIGNED CHECKED
					QC
					12

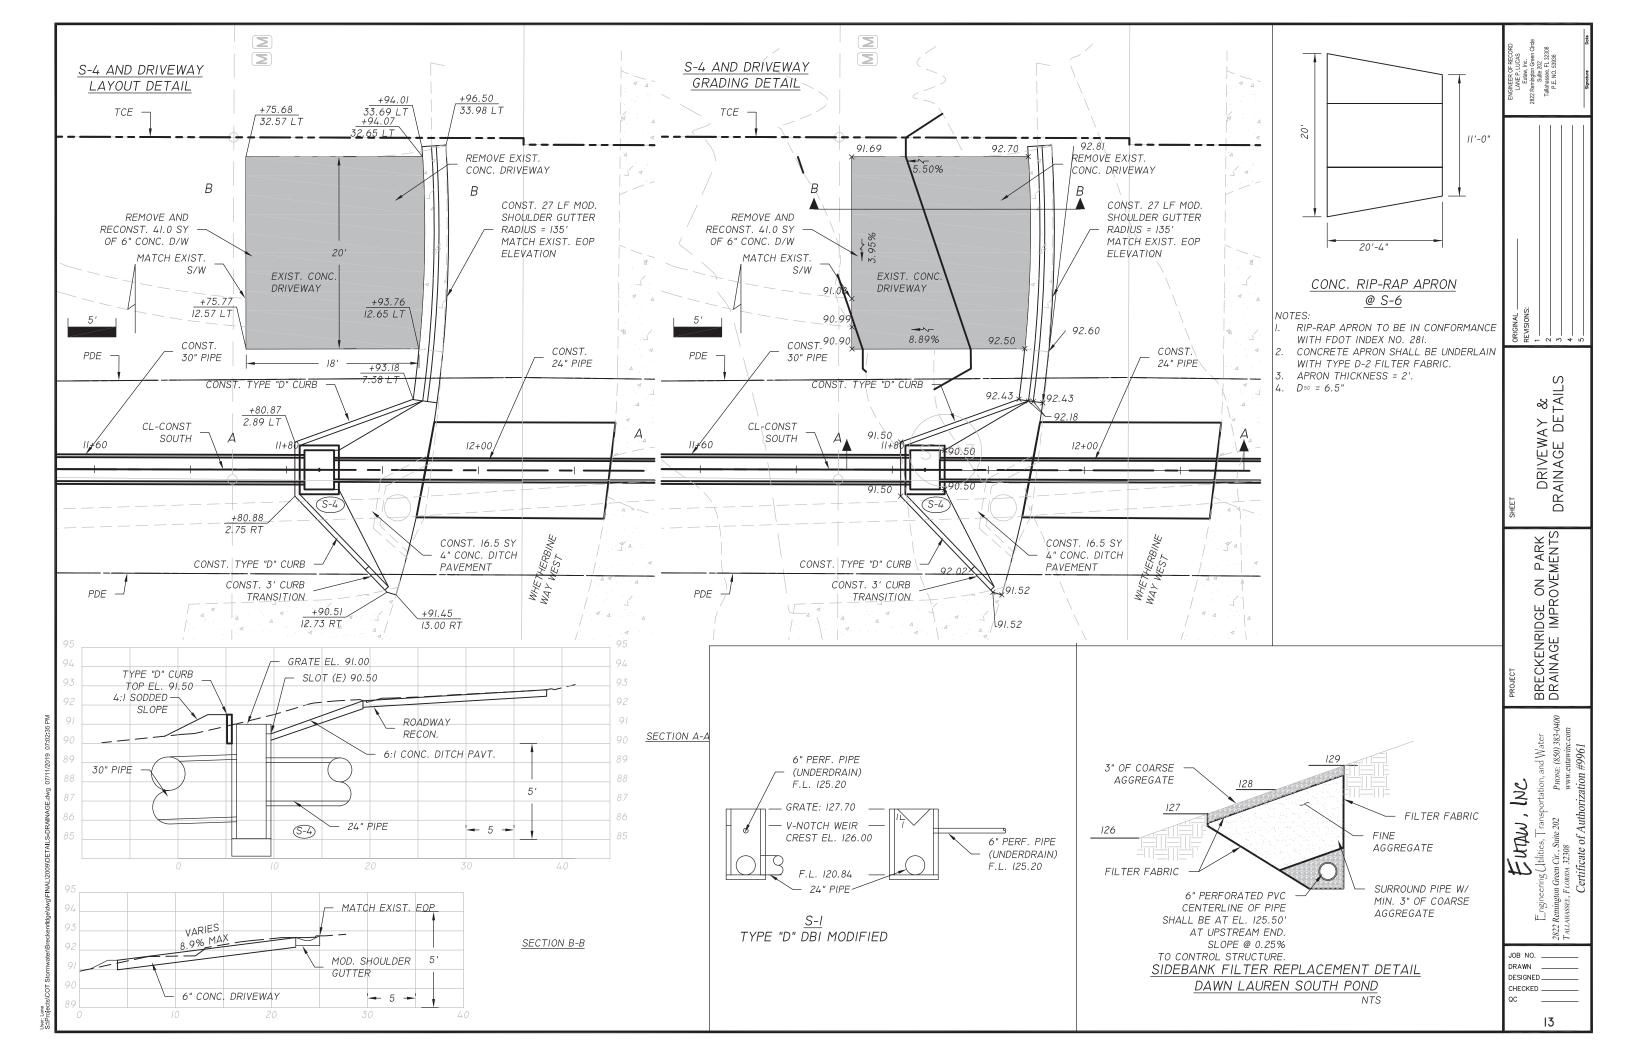

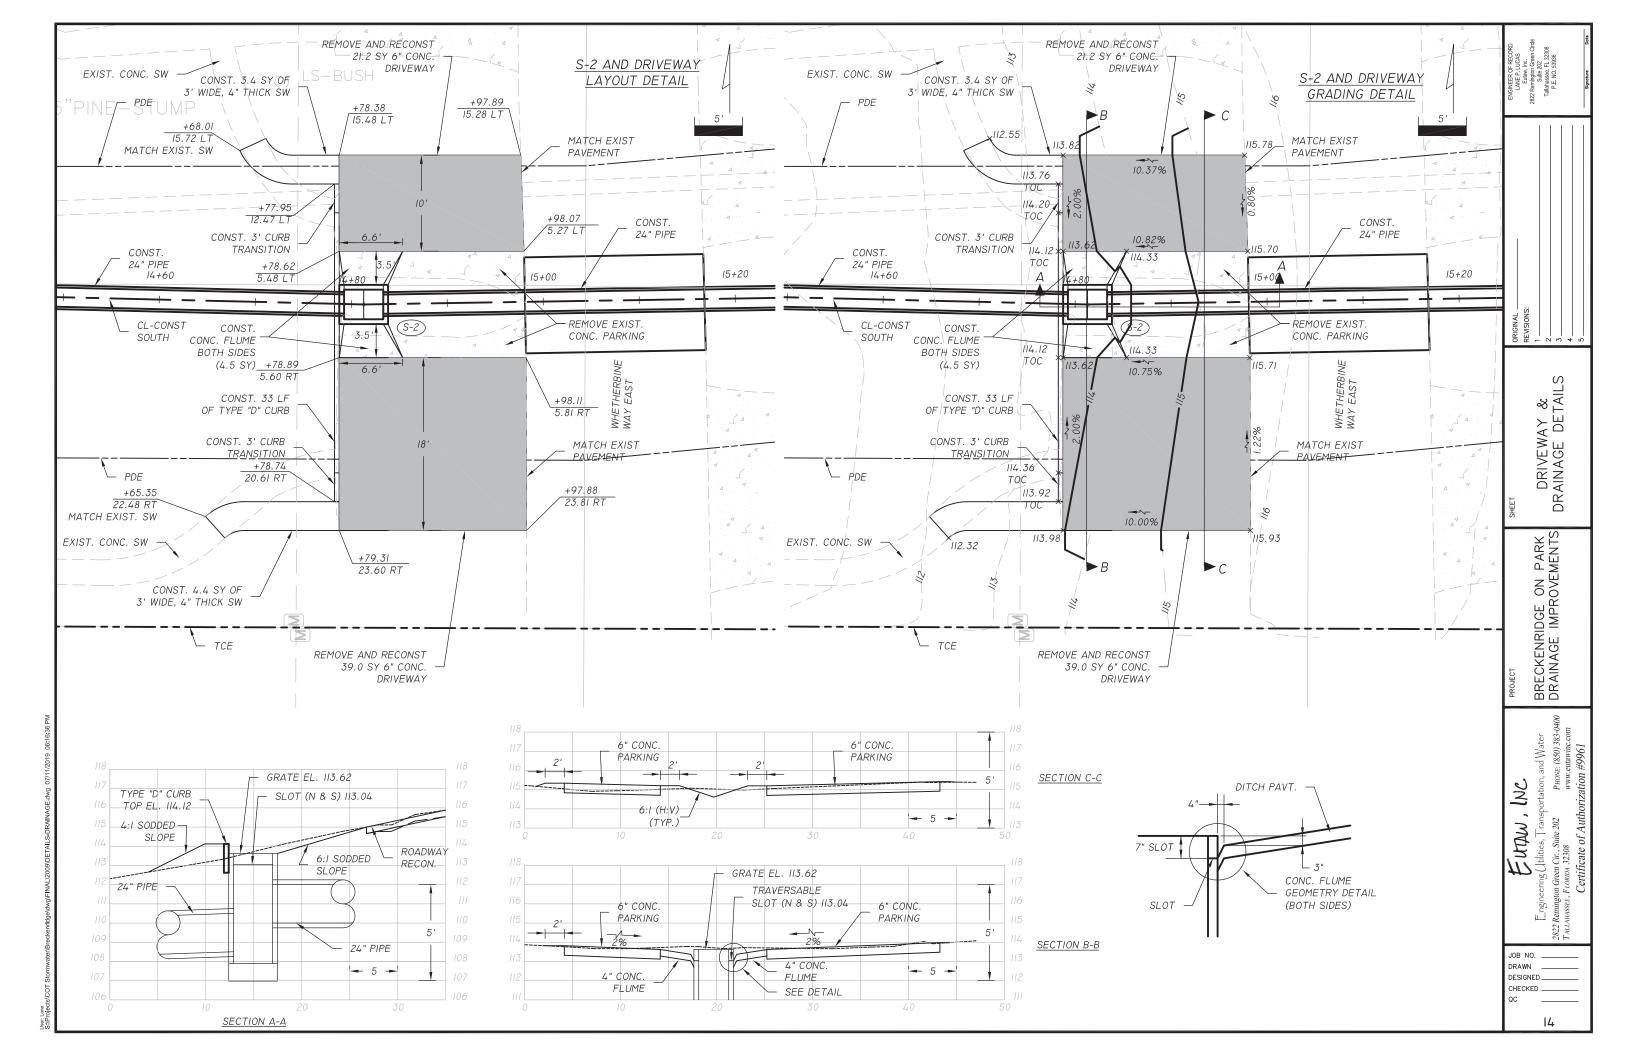




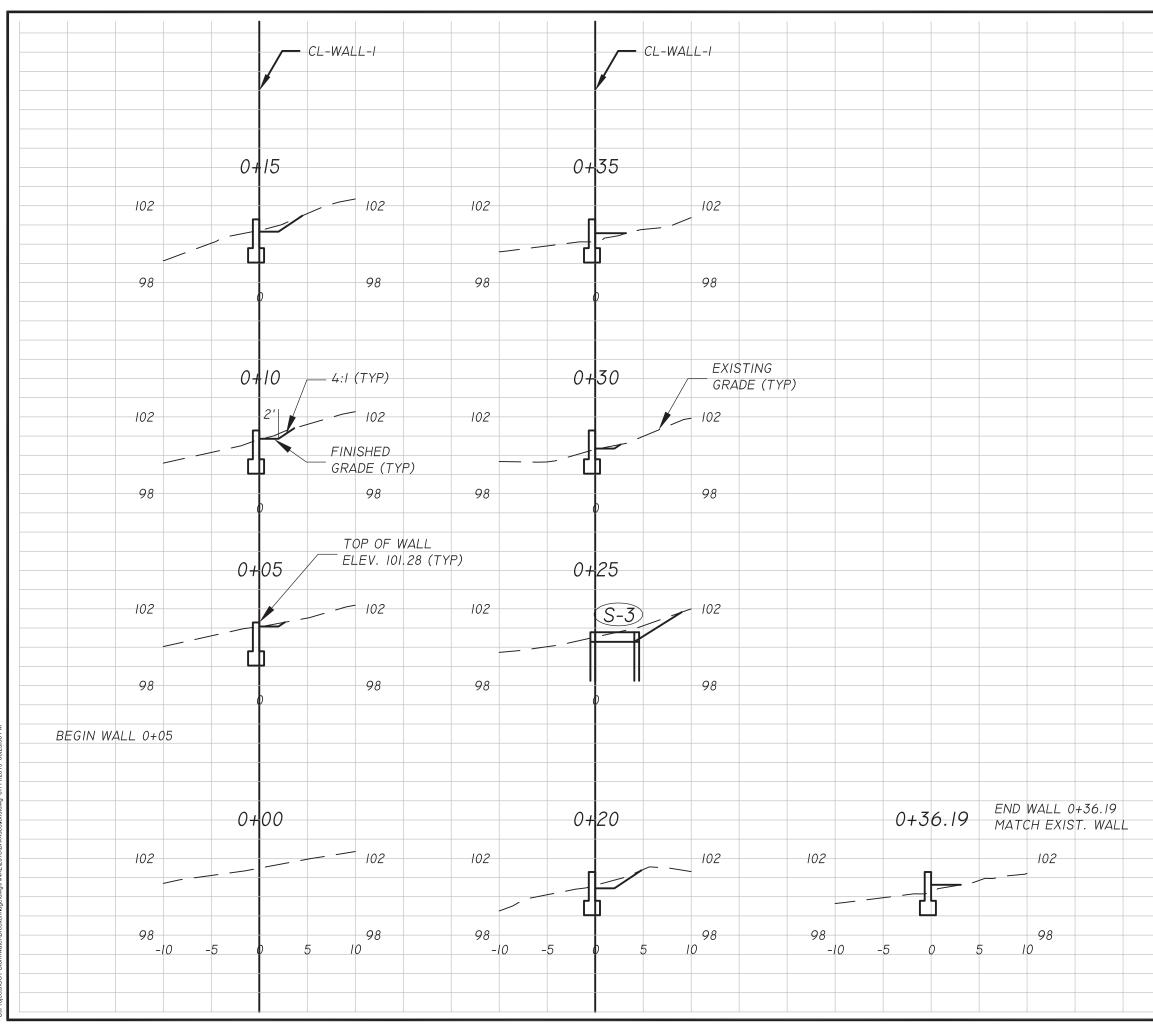


Image: Section of Authorstructure Application Image: Section of Authorstructure Application Image: Sec					
Bit Sector Se	ECORD CAS 2. 2. 2. 2. 2. 2. 2. 3. 3.2.308 336 336				
Bit Sector Se	ER OF F IE P. LUG utaw, Inc ington Gi Sulte 202 Issee, FL ISSee, FL				
Bit Sector Se	ENGINE LAN 22 Remi 7allaha P.E				
Biggeneration Biggeneration Biggeneration Biggeneration Biggeneration Biggeneration Biggeneration Biggeneration Contribute of Authorization Biggeneration Biggeneration Biggeneration	- 58				
Biggeneration Biggeneration Biggeneration Biggeneration Biggeneration Biggeneration Biggeneration Biggeneration Contribute of Authorization Biggeneration Biggeneration Biggeneration					
Biggeneration Biggeneration Biggeneration Biggeneration Biggeneration Biggeneration Biggeneration Biggeneration Contribute of Authorization Biggeneration Biggeneration Biggeneration					
Biggeneration Biggeneration Biggeneration Biggeneration Biggeneration Biggeneration Biggeneration Biggeneration Contribute of Authorization Biggeneration Biggeneration Biggeneration					
Biggeneration Biggeneration Biggeneration Biggeneration Biggeneration Biggeneration Biggeneration Biggeneration Contribute of Authorization Biggeneration Biggeneration Biggeneration					
Biggeneration Biggeneration Biggeneration Biggeneration Biggeneration Biggeneration Biggeneration Biggeneration Contribute of Authorization Biggeneration Biggeneration Biggeneration					
Biggeneration Biggeneration Biggeneration Biggeneration Biggeneration Biggeneration Biggeneration Biggeneration Contribute of Authorization Biggeneration Biggeneration Biggeneration					
Biggeneration Biggeneration Biggeneration Biggeneration Biggeneration Biggeneration Biggeneration Biggeneration Contribute of Authorization Biggeneration Biggeneration Biggeneration					
Biggeneration Biggeneration Biggeneration Biggeneration Biggeneration Biggeneration Biggeneration Biggeneration Contribute of Authorization Biggeneration Biggeneration Biggeneration					
Biggeneration Biggeneration Biggeneration Biggeneration Biggeneration Biggeneration Biggeneration Biggeneration Contribute of Authorization Biggeneration Biggeneration Biggeneration	AL AL				
Dependent Dependent Dependent Dependent Dependent Dependent Description Dependent Definition Definition	ORIGIN REVISI 3 3 5 1				
Dependent Dependent Dependent Dependent Dependent Dependent Description Dependent Definition Definition					
Dependent Dependent Dependent Dependent Dependent Dependent Description Dependent Definition Definition					
Dependent Dependent Dependent Dependent Dependent Dependent Description Dependent Definition Definition	ALL				
Dependent Dependent Dependent Dependent Dependent Dependent Description Dependent Definition Definition	N S I				
Dependent Dependent Dependent Dependent Dependent Dependent Description Dependent Definition Definition					
Dependent Dependent Dependent Dependent Dependent Dependent Description Dependent Definition Definition	DETAIL				
Description Description Description Description Description Description Description Description	H H				
Description Description Description Description Description Description Description Description	E E E				
Definition #961					
Definition #961	NTS				
Definition #961	PAF				
Definition #961	NON				
Definition #961	ПР И Р И С П Р И С				
Definition #961	l ari ari				
Definition #961	KEN				
Definition #961					
Designed Green Cir. Suite 202 Turwwsee: Friends 33308 Certificate of Authori	E E E				
Designed Green Cir. Suite 202 Turwwsee: Friends 33308 Certificate of Authori	2 2 2400				
Designed Green Cir. Suite 202 Turwwsee: Friends 33308 Certificate of Authori	JATET JATET 383-(2000				
Designed Green Cir. Suite 202 Turwwsee: Friends 33308 Certificate of Authori	AND AND (850) utawino				
JOB NO. DRAWN DRAWN DESIGNED CHECKED QC	INC RHONE, WWW.05				
JOB NO. DRAWN DRAWN DESIGNED CHECKED QC), (orents	_			
JOB NO. DRAWN DRAWN DESIGNED CHECKED QC	e 202 AU		4		
JOB NO. DRAWN DRAWN DESIGNED CHECKED QC	Le o He o He o		E E T		
JOB NO. DRAWN DRAWN DESIGNED CHECKED QC	Truin Treen Ci 32308 'tificc		371		
JOB NO. DRAWN DRAWN DESIGNED CHECKED QC	24NGT U gton Gr LORIDA 3			- 10	
JOB NO. DRAWN DRAWN DESIGNED CHECKED QC	rtNEETe Remine Assec, F		<u> </u>	10	
DRAWN DESIGNED OPERATION	ENG 2822 TALLAH				
DESIGNED CHECKED QC					
QC	DESIGNED				
I5	QC				
	15				

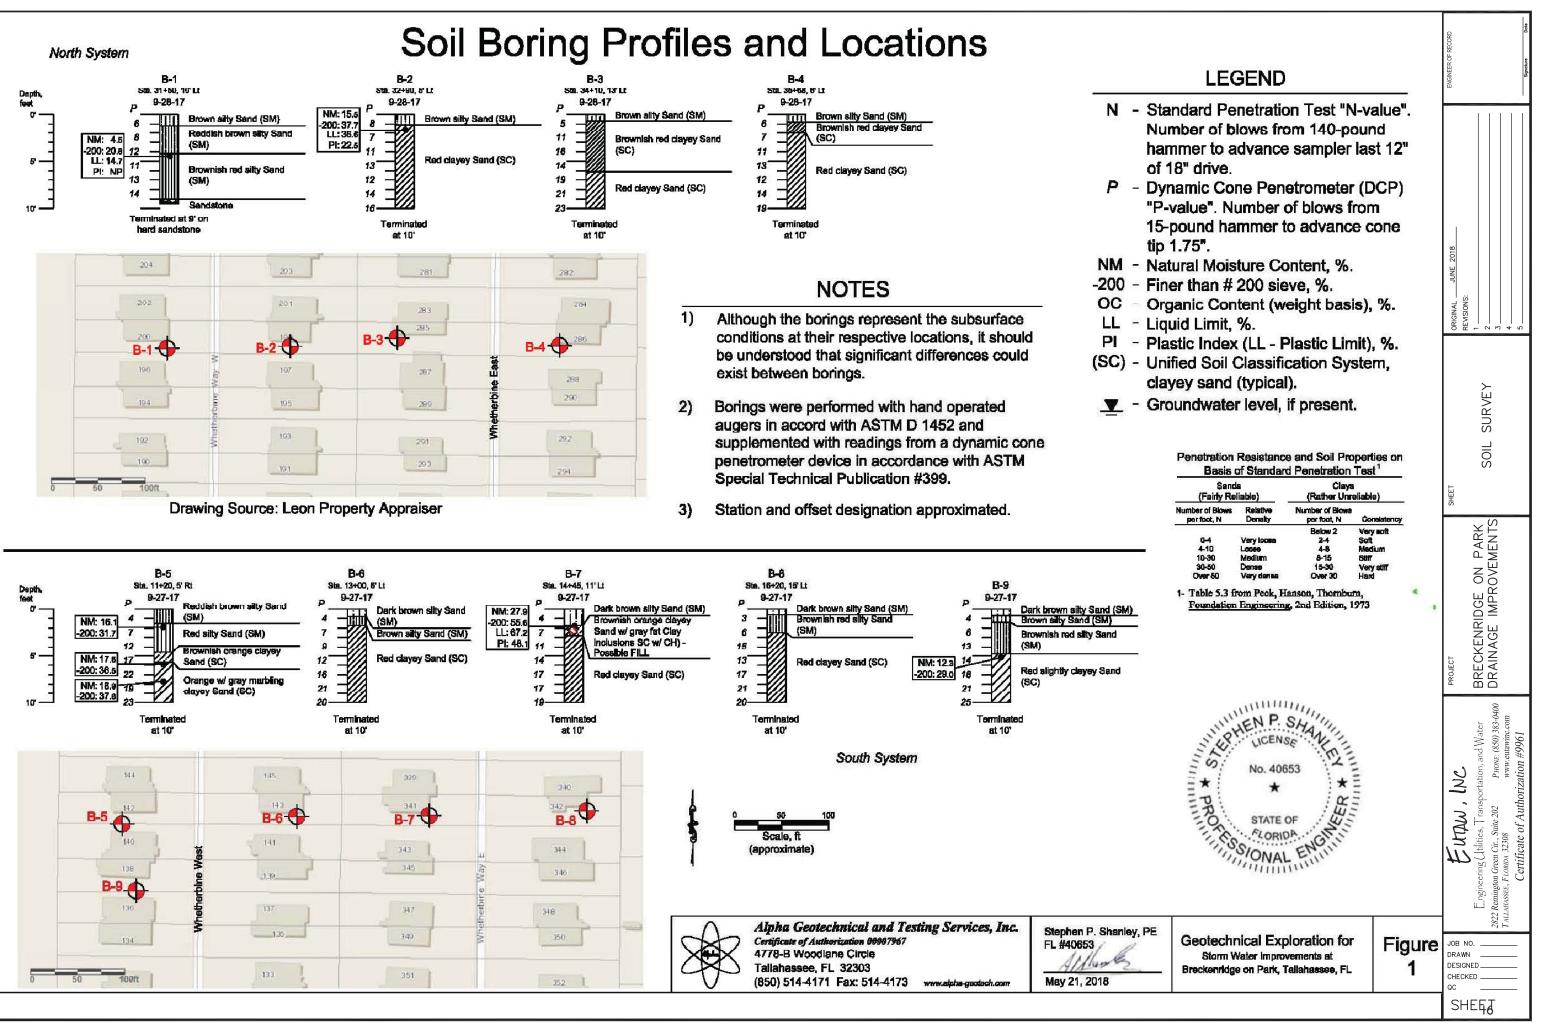

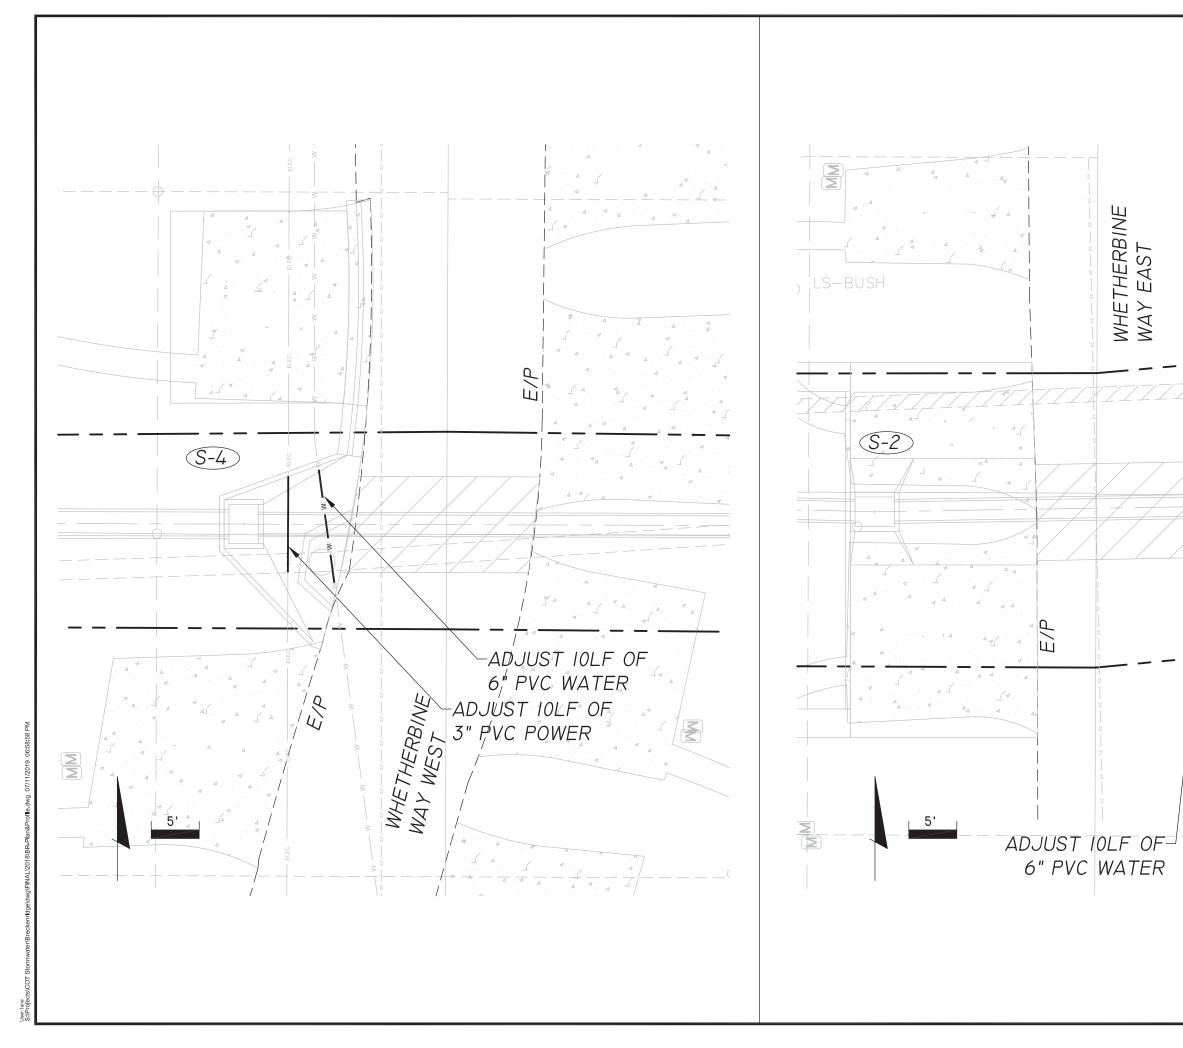

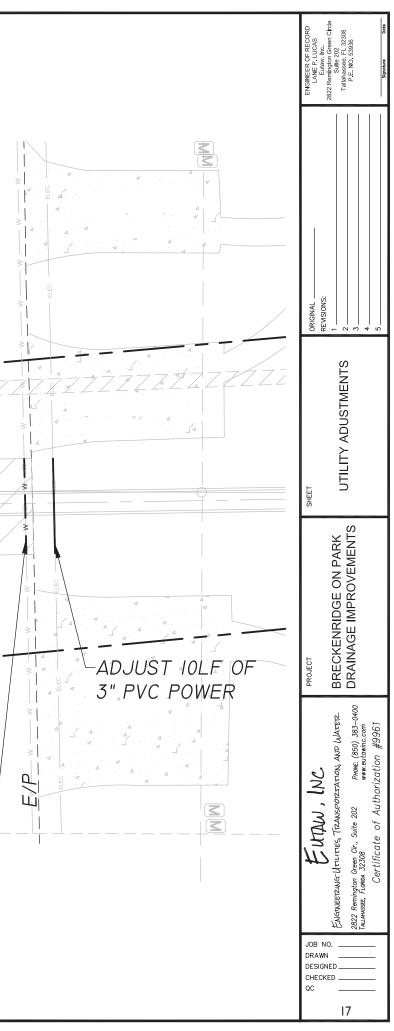

Ι.	SITE	DESCRIPTION	

A. CONSTRUCTION ACTIVITY:

FEATURES.

THE PROJECT CONSISTS OF RECONSTRUCTING EXISTING DRAINAGE INFRASTRUCTURE THROUGH AN EXISTING RESIDENTIAL DEVELOPMENT. THE PROJECT INCLUDES CLEARING AND GRUBBING, REMOVAL OF EXISTING DRAINAGE STRUCTURES, INSTALLATION OF DRAINAGE STRUCTURES AND PIPING, ROADWAY RECONSTRUCTION (PATCHING), UTILITY ADJUSTMENTS. RETAINING WALL CONSTRUCTION. AND PERMANENT EROSION CONTROL

B. MAJOR SOIL DISTURBING ACTIVITIES:

CLEARING AND GRUBBING DRAINAGE STRUCTURES AND PIPING (REMOVAL AND INSTALLATION)

C. AREA ESTIMATES:

TOTAL PROJECT AREA: 0.76 ACRES TOTAL AREA TO BE DISTURBED: 0.26 ACRES

D. RUNOFF DATA:

RUNOFF COEFFICIENT (BEFORE CONSTRUCTION): 0.45 RUNOFF COEFFICIENT (DURING CONSTRUCTION): 0.48 RUNOFF COEFFICIENT (AFTER CONSTRUCTION): 0.45

OUTFALL LOCATIONS:

THE PROJECT HAS ONE (I) OUTFALL TO THE PARK AVENUE TRIBUTARY #2. N 30°26'39.0" W 84°13'51.9"

2. CONTROLS

SEQUENCE OF SOIL DISTURBING ACTIVITIES AND IMPLEMENTATION OF CONTROLS:

CONTROLS SHALL BE INSTALLED PRIOR TO ANY EARTH CLEARING ACTIVITIES AND MAINTAINED UNTIL PERMANENT EROSION CONTROL FEATURES HAVE BEEN ESTABLISHED.

A. EROSION AND SEDIMENT CONTROLS

(I) STABILIZATION PRACTICES:	
TEMPORARY SODDING	
TEMPORARY GRASSING	
PERMANENT SODDING OR SEEDING	
(2) STRUCTURAL PRACTICES:	
SEDIMENT BARRIER	
INLET PROTECTION SYSTEM	
BERMS	
SEDIMENT TRAPS/BASINS	
	-

B. STORMWATER MANAGEMENT

STORMWATER MANAGEMENT IS PROVIDED IN THE UPPER AREAS OF THE PROJECT AREA (EXISTING STORMWATER FACILITIES). NO NEW STORMWATER MANAGEMENT FACILITIES WILL BE CONSTRUCTED AS THERE IS NO NEW IMPERVIOUS AREA ASSOCIATED WITH THE PROJECT.

C. OTHER CONTROLS

(I) WASTE DISPOSAL: THE CONTRACTOR IS RESPONSIBLE FOR DOCUMENTING THIS PORTION OF THE SWPPP.

(2) OFFSITE VEHICLE TRACKING AND GENERATION OF DUST: HAUL ROADS DAMPENED FOR DUST CONTROL LOADED HAUL TRUCKS TO BE COVERED WITH TARP EXCESS DIRT ON ROADWAY REMOVED DAILY

STABILIZED CONSTRUCTION ENTRANCE

(3) SANITARY OR SEPTIC WASTE:

ALL SANITARY WASTE WILL BE COLLECTED AS NECESSARY OR AS REQUIRED BY LOCAL REGULATION BY A LICENSED SANITARY WASTE MANAGEMENT CONTRACTOR. THE CONTRACTOR IS RESPONSIBLE FOR DOCUMENTING THIS PORTION OF THE SWPPP.

(4) FERTILIZER:

FERTILIZER SHALL BE APPLIED ACCORDING TO THE MANUFACTURER'S RECOMMENDATIONS BY A LICENSED OR CERTIFIED APPLICATOR AS DIRECTED BY THE PROJECT ENGINEER.

(5) PESTICIDES:

THE CONTRACTOR IS RESPONSIBLE FOR DOCUMENTING THIS PORTION OF THE SWPPP.

(6) NON-STORM WATER DISCHARGE INCLUDING SPILL REPORTING: NO NON-STORM WATER DISCHARGES ARE ANTICIPATED.

3. PERM

PERMITS OBT

4. MAIN

ALL EROSION FOLLOWING E SHALL BE MA CONTROLS SH

THE CONTRAC PORTION OF

5. INSP

ALL CONTROL CONTRACTOR OR MORE OF WILL BE MAD RESULTS. TH INSPECTION F

MITS TAINED FOR THIS PROJECT INCLUDE:	ENGINEER OF RECORD LANE P. LUCAS, P. E. LANE P. LUCAS, P. E. 2322 Rennington Green Circle 2322 Rennington Coren Circle Talanssea, H. 23208 P. N.O. 5336 P. E. NO. 5336
NTENANCE N AND SEDIMENT CONTROLS SHALL BE INSPECTED EACH RAINFALL EVENT. ANY REQUIRED REPAIRS ADE IMMEDIATELY. SEDIMENT DEPOSITS AT THE SHOULD BE REMOVED AFTER EACH STORM EVENT. ACTOR IS RESPONSIBLE FOR DOCUMENTING THIS THE SWPPP.	ORIGINAL ORIGINAL REVISIONS: 1 2 3 3 5
PECTION DLS SHALL BE INSPECTED WEEKLY BY THE R AS WELL AS AFTER A STORM EVENT WITH 0.50" TRAIN. AN INSPECTION AND MAINTENANCE REPORT DE PER EACH INSPECTION BASED UPON INSPECTION THE CONTROLS SHALL BE REVISED PER THE RESULTS.	STORMWATER STORMWATER POLLUTION PREVENTION PLAN
	PROJECT BRECKENRIDGE ON PARK DRAINAGE IMPROVEMENTS
	Engineering (Ltilities, Transportation, and Water Engineering (Ltilities, Transportation, and Water 2822 Remington Green Cir., Suite 202 PHONE (850) 383-0400 TALIAHASEE, FLORIDA 32308 WWW.eutawine.com Certificate of Authorization #9961
	JOB NO DRAWN DESIGNED CHECKED QC 18

THESE PLANS. THE SEDIMENT AND EROSION CONTROL PLAN SHALL BE PREPARED IN ACCORDANCE WITH THE "FLORIDA EROSION AND SEDIMENT CONTROL MANUAL" AND SHALL BE SPECIFIC TO THE MEANS, METHODS, AND SEDUENCE OF CONSTRUCTION TO BE EMPLOYED BY THE CONTRACTOR AND SHALL DEDRIFY THE TYPES AND LOCATIONS OF CONTROLS THAT ARE TO BE IMPLEMENTED DURING EACH PHASE OF CONSTRUCTION AS SHOWN ON THE APPROVED CONSTRUCTION SCHEDULE TO MINIMIZE EROSION, PREVENT THE TRANSFER OF ERODED MATERIALS ONTO ANY OFF SITE PARCEL OR INTO ANY RECEIVING WATER, AND PREVENT VIOLATING STATE AND/OR FEDERAL PERMIT REQUIREMENTS. PAYMENT FOR PREPARING AND SUBMITTING THE SEDIMENT AND EROSION CONTROL PLAN AND FOR ANY MODIFICATIONS TO THE SEDIMENT AND EROSION CONTROL PLAN DURING CONSTRUCTION WILL BE INCLUDED IN THE PAY ITEM FOR MODIFICATIONS. THE SEDIMENT AND EROSION CONTROL PLAN SHALL DESCRIBE BUT NOT BE LIMITED TO THE FOLLOWING ITEMS FOR EACH PHASE OF CONSTRUCTION OPERATIONS OR ACTIVITIES.

POLLUTANTS OFF SITE OR INTO ANY RECEIVING WATER AND SHALL SUBMIT THE UPDATED PLAN FOR REVIEW AND APPROVAL BY THE ENGINEER.


ENGINEER


THAT THE DEVICES ARE PROPERLY LOCATED AND MAINTAINED FOR EFFECTIVENESS. ANY REQUIRED REMEDIAL ACTION SHALL BE PERFORMED IMMEDIATELY

8. SEDIMENT TRAPPED BY THE EROSION CONTROL DEVICES IS TO BE REMOVED BY THE CONTRACTOR AFTER EACH RAIN STORM.


WEATHER, AND AREAS OUTSIDE THE LIMITS OF CONSTRUCTION SHALL NOT BE DISTURBED

- FILTERS SHALL BE PLACED ACROSS THE THROATS OF ALL EXISTING AND COMPLETED CURB INLETS.
- FLOWS FROM THE EXISTING PIPES TO THE NEW PIPES PRIOR TO RAIN STORMS. TEMPORARY PIPES SHALL BE PLACED FOR THIS PURPOSE PRIOR TO SUSPENSION OF WORK ACTIVITIES EACH DAY.
- HAS TEMPORARILY OR PERMANENTLY CEASED
- 16. THE CONTRACTOR SHALL OBTAIN AN ENVIRONMENTAL MANAGEMENT PERMIT FROM THE CITY OF TALLAHASSEE GROWTH MANAGEMENT DEPARTMENT FOR ALL STOCKPILE AND CONSTRUCTION STAGING AREAS LOCATED OUTSIDE THE LIMITS OF CONSTRUCTION.

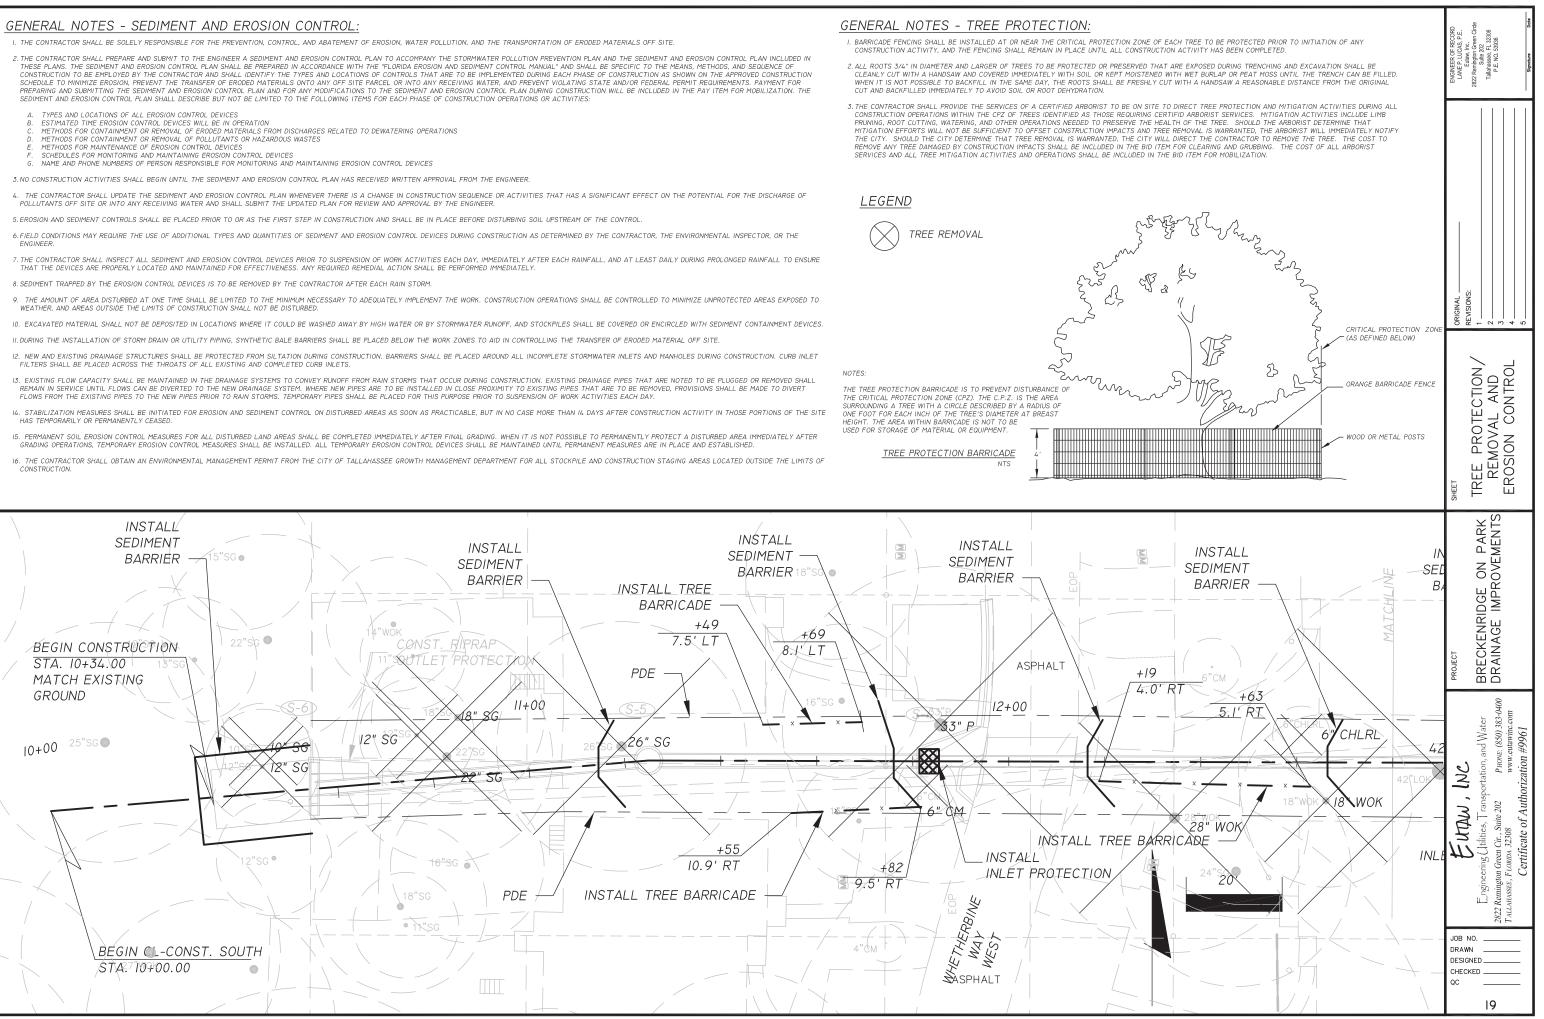

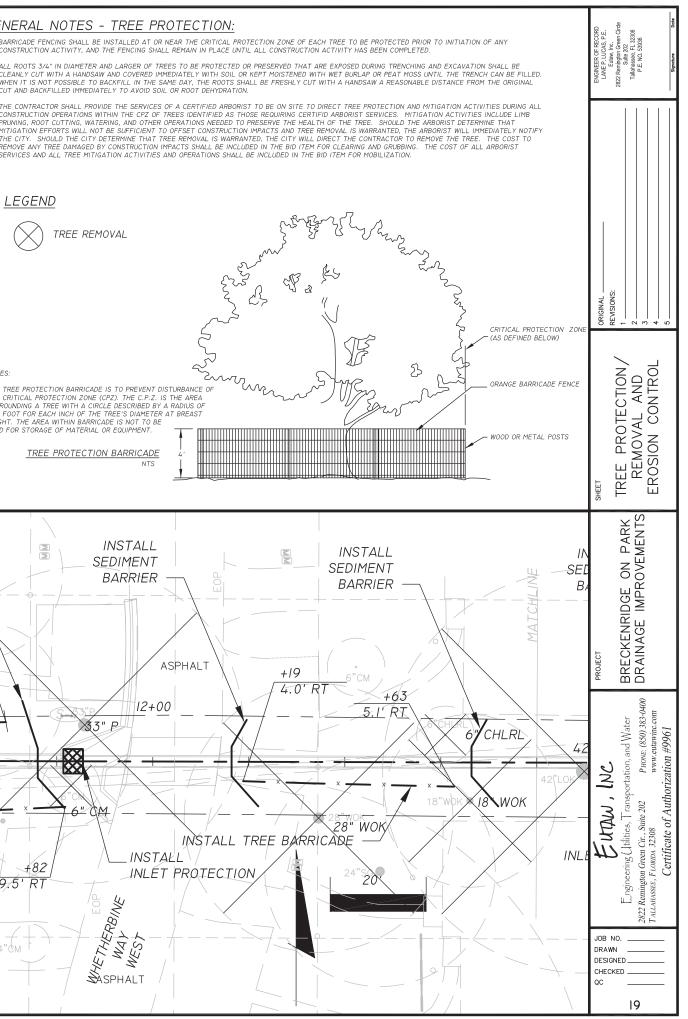



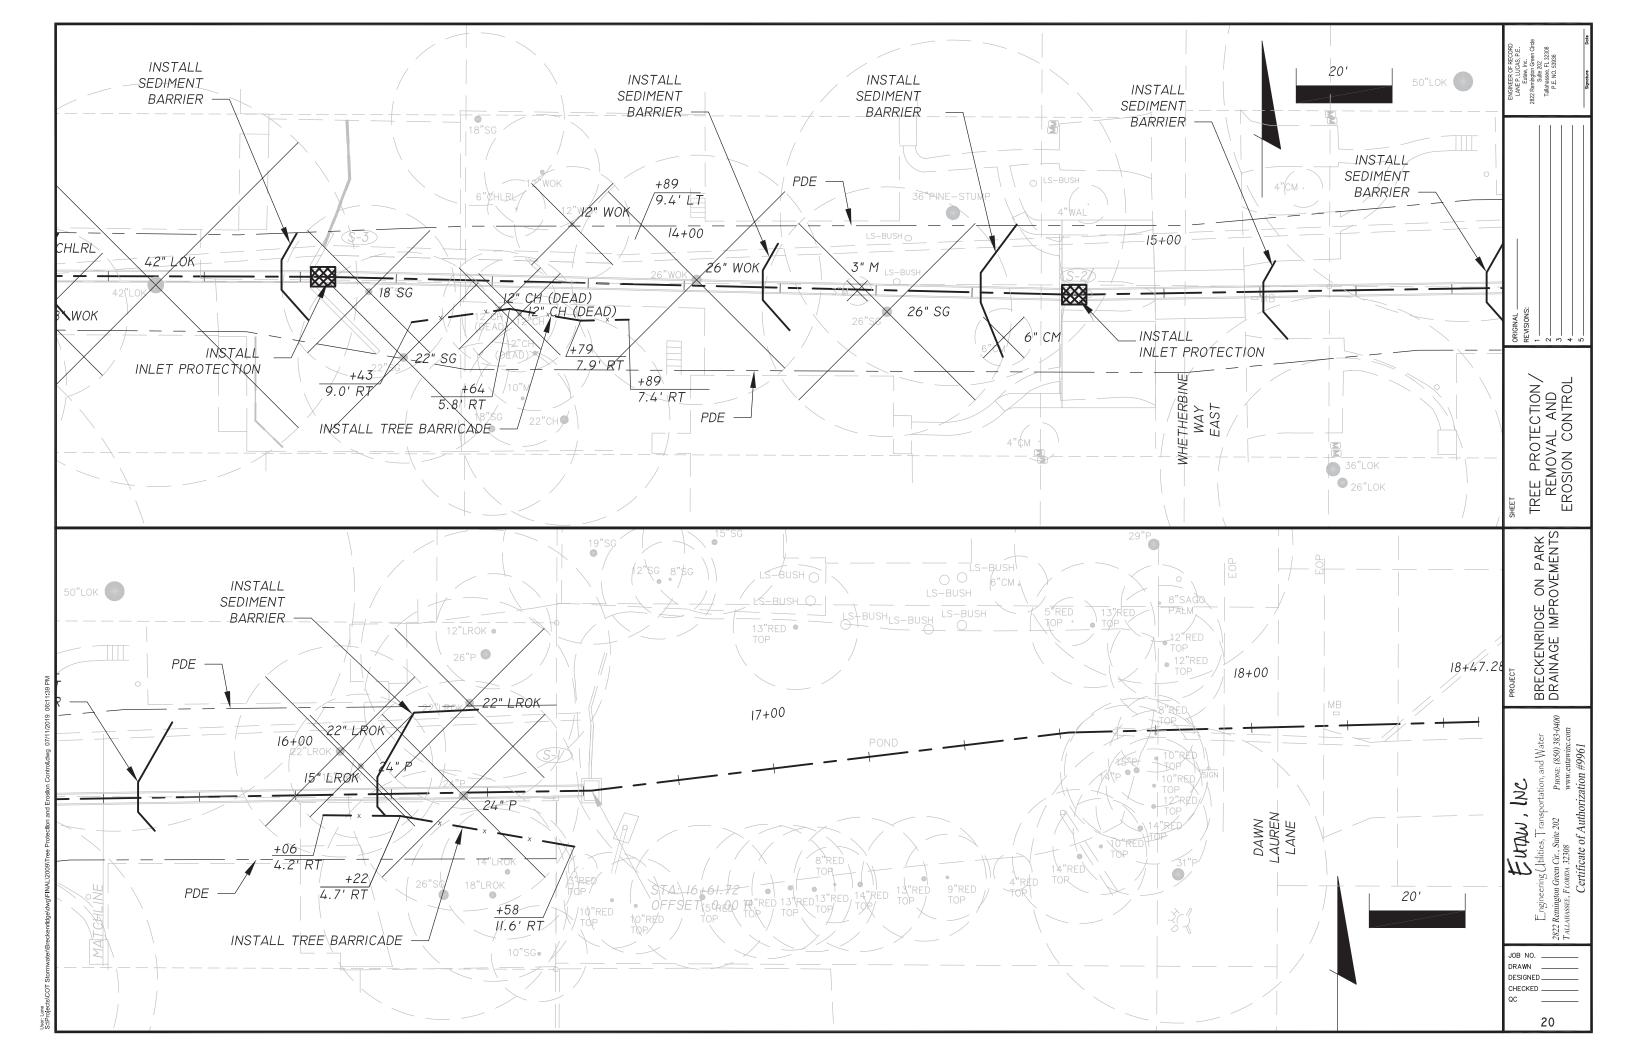


TRAFFIC CONTROL NOTES

- THE CONTRACTOR SHALL PREPARE A TRAFFIC CONTROL PLAN THAT DESCRIBES THE MEASURES TO BE EMPLOYED DURING CONSTRUCTION TO WARN MOTORISTS AND PEDESTRIANS OF HAZARDS, TO ADVISE MOTORISTS OF THE PROPER TRAVEL PATH THROUGH OR AROUND THE WORK AREA, TO DELINEATE AREAS WHERE TRAFFIC SHOULD NOT OPERATE, AND TO SEPARATE AND PROTECT MOTORISTS, PEDESTRIANS, AND THE WORK FORCE DURING ALL PHASES OF THE WORK. THE PLAN SHALL ALSO CONSIDER ACCESS TO BUSINESSES WITHIN THE CONSTRUCTION AREA AND PROVIDE BUSINESS ENTRANCE SIGNS TO ROUTE MOTORISTS TO DESIGNATED PARKING AREAS. THE CONTRACTOR SHALL OBTAIN APPROVAL OF THE TRAFFIC CONTROL PLAN FROM THE CITY OF TALLAHASSEE TRAFFIC MOBILITY MANAGEMENT SECTION PRIOR TO BEGINNING CONSTRUCTION. PAYMENT FOR PREPARING AND SUBMITTING THE TRAFFIC CONTROL PLAN SHALL BE INCLUDED IN THE PAY ITEM FOR MOBILIZATION.
- 2. ACCESS TO BUSINESS AND RESIDENTIAL DRIVEWAYS SHALL BE MAINTAINED AT ALL TIMES.
- NO ROADWAYS (INCLUDING COUNTY ROADS) SHALL BE CLOSED WITHOUT PRIOR APPROVAL OF THE CITY OF TALLAHASSEE TRAFFIC 3. MOBILITY MANAGEMENT SECTION.
- 4. ALL TRAFFIC CONTROL DEVICES SHALL BE INSTALLED IN ACCORDANCE WITH THE MANUAL ON UNIFORM TRAFFIC CONTROL DEVICES AND/OR THE FLORIDA DEPARTMENT OF TRANSPORTATION DESIGN STANDARDS, 600 SERIES.
- 5. ALL TRAFFIC CONTROL DEVICES SHALL BE IN PLACE BEFORE THE START OF CONSTRUCTION ON AFFECTED ROADWAYS.
- WARNING LIGHTS SHALL BE USED ON BARRICADES DURING HOURS OF DARKNESS IN ACCORDANCE WITH INDEX NO. 600. 6.
- ON WHETHERBINE WAY EAST AND WEST, ROADWAY SEGMENTS UNDER CONSTRUCTION MAY BE CLOSED TO THROUGH TRAFFIC. ONLY 7. ONE PORTION OF WHETHERBINE WAY MAY BE CLOSED AT ANY TIME.
- WORK SHALL BE SCHEDULED WHERE ONLY ONE ROADWAY SEGMENT IS UNDER CONSTRUCTION AT A TIME. 8.
- 9. ALL SIGNING AND ADVANCE WARNING SHALL BE INSTALLED PRIOR TO CLOSING ROAD SEGMENTS.

SUGGESTED CONSTRUCTION SEQUENCE

THE FOLLOWING SEQUENCE IS RECOMMENDED FOR THE CONSTRUCTION OF THE PROPOSED IMPROVEMENTS:

- INSTALL EROSION CONTROL FEATURES
- 2. CLEARING AND GRUBBING
- 3. UTILITY ADJUSTMENTS
- 4. STORM SEWER CONSTRUCTION
- 5. RETAINING WALL CONSTRUCTION
- 6. ROADWAY STABILIZATION OPTIONAL BASE CONSTRUCTION 7
- 8. CURB CONSTRUCTION
- 9. DRIVEWAY CONSTRUCTION
- 10. PERMANENT EROSION CONTROL

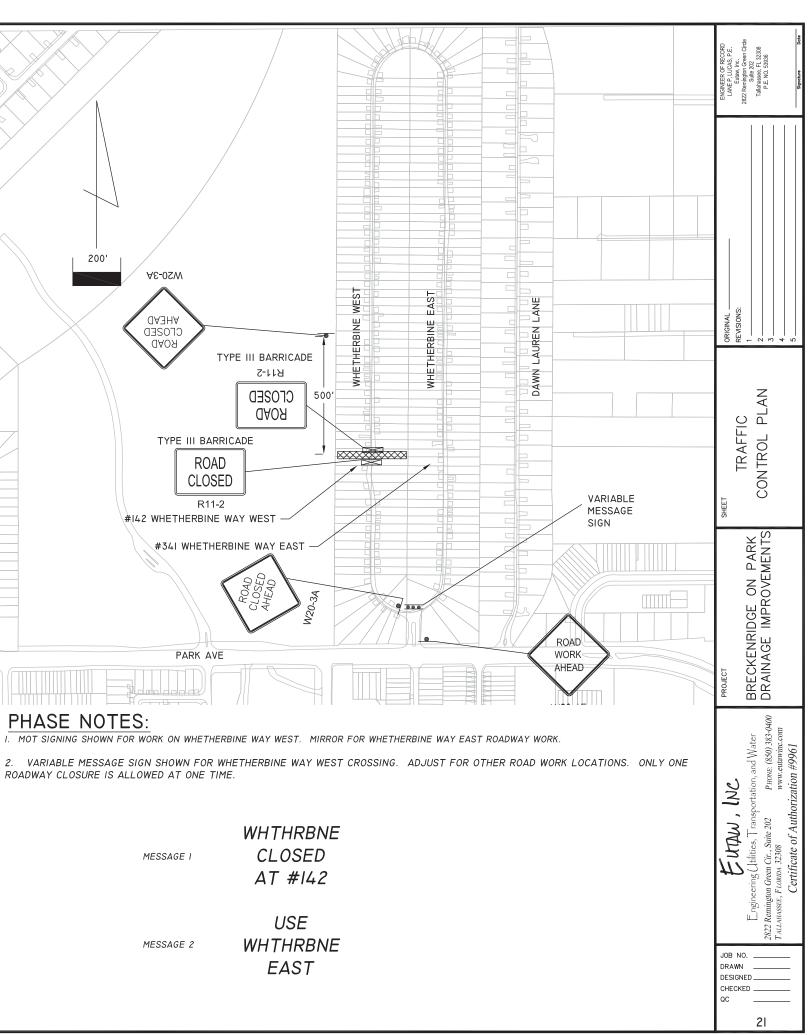

MESSAGE I	WHTHRBNE CLOSED AT #142
MESSAGE 2	USE WHTHRBNE EAST

NOTE: THIS PROJECT SHALL BE CONSTRUCTED CONCURRENTLY WITH THE BRECKENRIDGE ON PARK SOUTH DRAINAGE IMPROVEMENT PROJECT.

BRECKENRIDGE ON PARK NORTH DRAINAGE IMPROVEMENTS

PLANS PREPARED FOR:


THIS PLAN SET IS FOR INFORMATIONAL PURPOSES ONLY. NOT FOR **CONSTRUCTION.**



FLORIDA DEPARTMENT OF TRANSPORTATION, DESIGN STANDARDS DATED 2017-2018 AND STANDARD SPECIFICATIONS FOR ROAD AND BRIDGE CONSTRUCTION DATED 2018, AS AMENDED BY CONTRACT DOCUMENTS.

ATTENTION IS DIRECTED TO THE FACT THAT THESE PLANS MAY HAVE BEEN ALTERED IN SIZE BY REPRODUCTION. THIS MUST BE CONSIDERED WHEN OBTAINING SCALED DATA.

	REVISIONS					
NO.	NO. DESCRIPTION BY DATE					

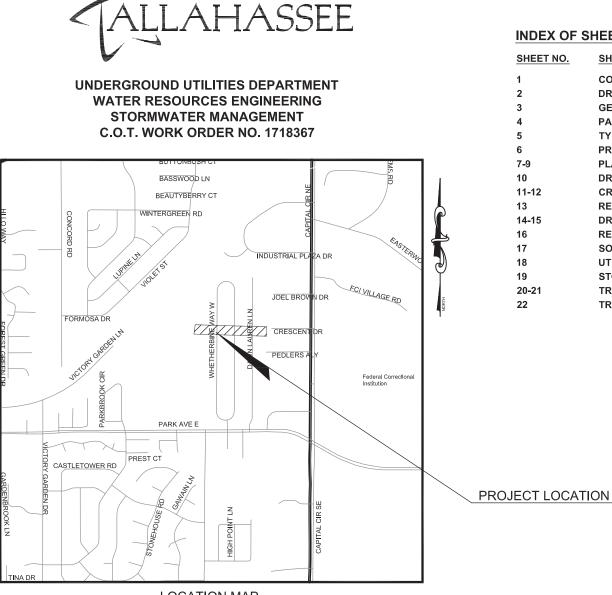

CITY OF

LOCATION MAP 1" = 800'

NORTH AMERICAN VERTICAL DATUM OF 1988

PLANS PREPARED BY:

EUTAW, INC.

2822 REMINGTON GREEN CIRCLE, SUITE 202 TALLAHASSEE, FLORIDA 32308 (850) 383-0400 WWW.EUTAWINC.COM

ENGINEER OF RECORD:

LANE P. LUCAS, P.E. FLORIDA PE #53936

CERTIFICATE OF AUTHORIZATION #9961

INDEX OF SHEETS

SHEET DESCRIPTION


COVER SHEET DRAINAGE MAP GENERAL NOTES PAY ITEM NOTES **TYPICAL SECTIONS & DETAILS** PROJECT LAYOUT **PLAN & PROFILE** DRAINAGE STRUCTURES CROSS SECTIONS **RETENTION/DETENTION POND DRIVEWAY & DRAINAGE DETAILS RETAINING WALL DETAILS** SOIL SURVEY UTILITY ADJUSTMENTS STORMWATER POLLUTION PREVENTION PLAN TREE PROTECTION/REMOVAL & EROSION CONTROL TRAFFIC CONTROL PLAN

APPROVED FOR CONSTRUCTION

STORMWATER MANAGEMENT DIVISION

DATE:

SET NO.: _____

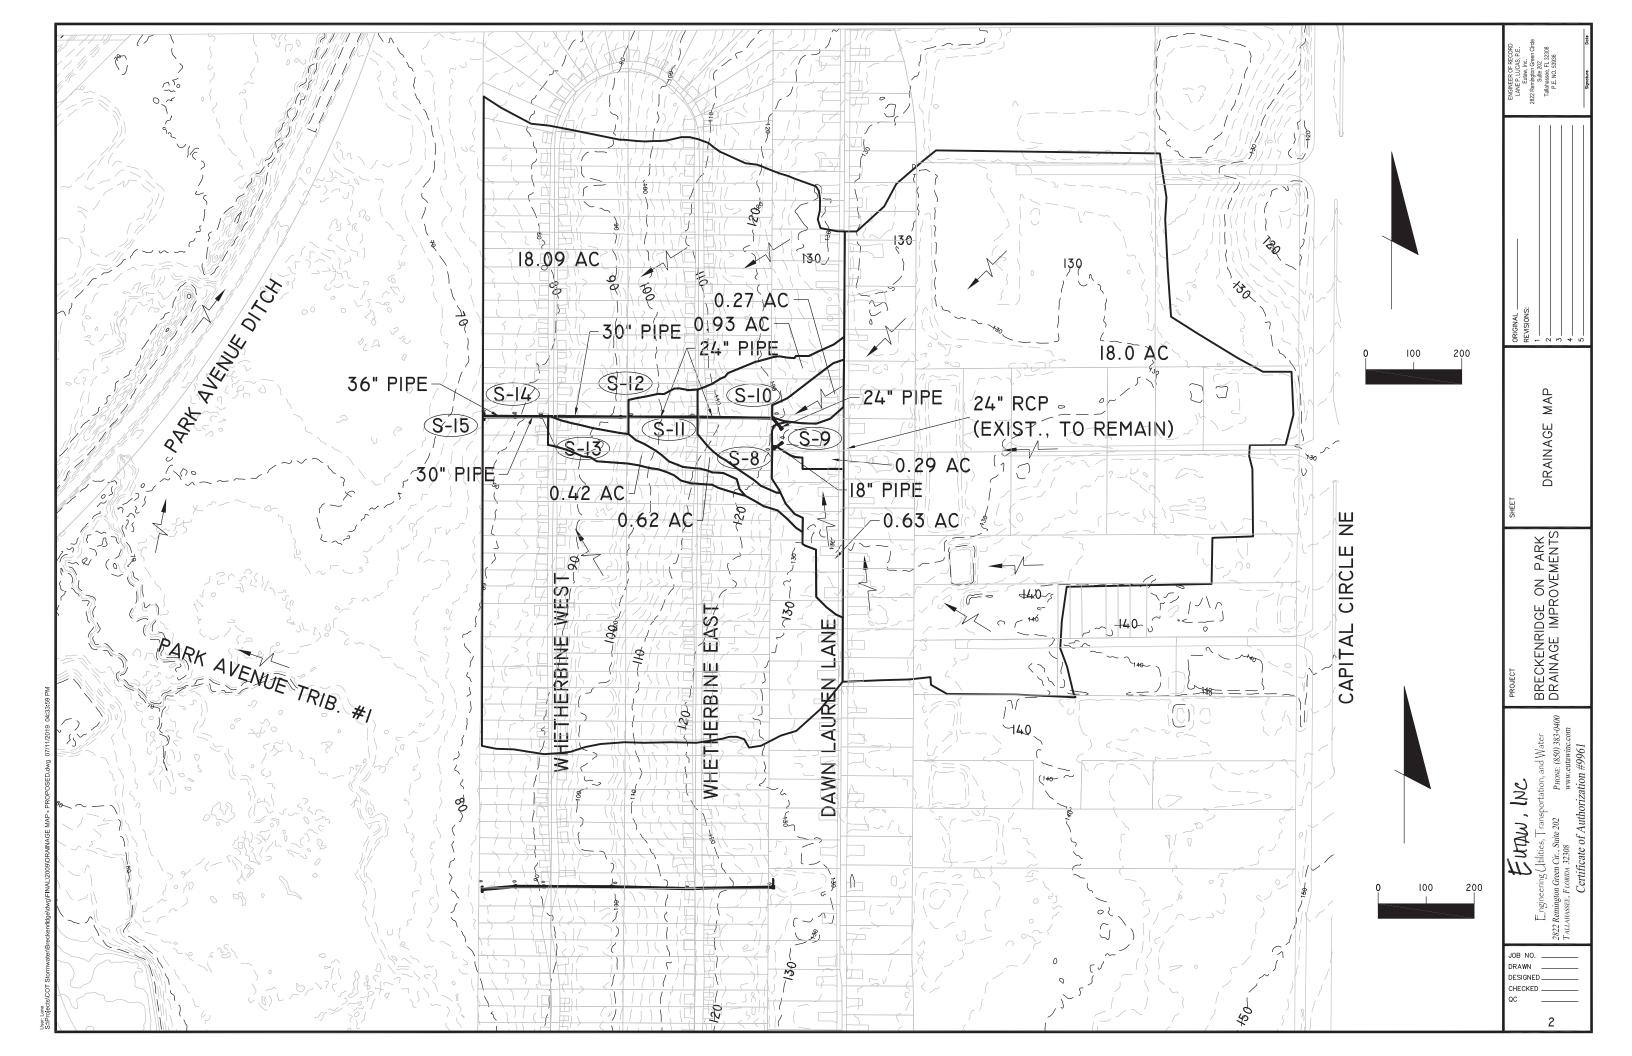

GENERAL NOTES:

- THE CONTRACTOR SHALL HAVE ALL REQUIRED PERMITS IN-HAND PRIOR TO BEGINNING CONSTRUCTION, AND SHALL PERFORM ALL WORK IN ACCORDANCE WITH THE REQUIREMENTS OF THE PERMITS OBTAINED BY THE CITY AND THOSE PERMITS OBTAINED BY THE CONTRACTOR.
- AT LEAST THREE CALENDAR DAYS PRIOR TO THE PRECONSTRUCTION CONFERENCE; THE CONTRACTOR SHALL SUBMIT TO THE ENGINEER FOR APPROVAL A TENTATIVE BASE CONSTRUCTION SCHEDULE, A PRECONSTRUCTION SURVEY A TRAFFIC CONTROL PLAN, AND A SEDIMENT AND EROSION CONTROL PLAN. NO WORK SHALL BEGIN PRIOR TO APPROVAL OF THE CONSTRUCTION SCHEDULE, PRECONSTRUCTION SURVEY, TRAFFIC CONTROL PLAN, AND SEDIMENT AND EROSION CONTROL PLAN.
- THE CONSTRUCTION SCHEDULE SHALL DESCRIBE IN DETAIL HOW THE CONSTRUCTION IS TO BE PHASED, ESTABLISH START AND FINISH DATES FOR ALL SIGNIFICANT CONSTRUCTION ACTIVITIES, AND IDENTIFY ALL CONTROLLING ITEMS OF WORK. THE SCHEDULE IS TO BE APPROVED BY THE ENGINEER, AND SHALL BE UPDATED ON A MONTHLY BASIS TO REFLECT ACTUAL WORK PROGRESS. THE UPDATED SCHEDULE SHALL BE SUBMITTED TO THE ENGINEER NO LATER THAN THREE DAYS PRIOR TO EACH SCHEDULED MONTHLY PROGRESS MEETING. PAYMENT FOR PREPARING, UPDATING AND SUBMITTING THE SCHEDULE SHALL BE INCLUDED IN THE PAY ITEM FOR MOBILIZATION.
- THE PRECONSTRUCTION SURVEY SHALL VERIFY THE CONTROL POINTS AND BENCH MARK ELEVATIONS PROVIDED BY THE ENGINEER AND SHALL ALSO ESTABLISH THE LOCATION AND DESCRIPTION OF ALL ADDITIONAL REFERENCE POINTS AND THE LOCATIONS. DESCRIPTIONS. AND ELEVATIONS OF ALL ADDITIONAL BENCHMARKS TO BE USED IN CONSTRUCTING THE PROJECT. THE SURVEY SHALL BE SIGNED AND SEALED BY A PROFESSIONAL SURVEYOR AND MAPPER REGISTERED IN THE STATE OF FLORIDA. SIGNIFICANT INCONSISTENCIES BETWEEN THE FIELD NOTES AND THE CONTROL POINTS AND BENCH MARK ELEVATIONS PROVIDED BY THE ENGINEER SHALL IMMEDIATELY BE BROUGHT TO THE ATTENTION OF THE ENGINEER FOR RESOLUTION PRIOR TO ISSUANCE OF THE NOTICE TO PROCEED. PAYMENT SHALL BE INCLUDED IN THE PAY ITEM FOR MOBILIZATION.
- THE GEOTECHNICAL INFORMATION SHOWN ON THE DRAWINGS WAS OBTAINED FOR USE IN ESTABLISHING DESIGN CRITERIA FOR THE PROJECT. THIS INFORMATION MAY NOT ACCURATELY REFLECT ACTUAL SOIL CONDITIONS AS TO THE DEPTH, EXTENT OR CHARACTER OF THE MATERIAL TO BE ENCOUNTERED IN CONSTRUCTION OF THE PROJECT. IT IS THE RESPONSIBILITY OF THE CONTRACTOR TO MAKE SUCH EXAMINATION OF THE SITE OF THE WORK AS MAY BE NECESSARY TO DETERMINE THE CONDITIONS UNDER WHICH THE WORK IS TO BE PERFORMED
- THE CONTRACTOR IS RESPONSIBLE FOR PRESERVING ALL PROPERTY CORNERS AND MONUMENTS SHOWN ON THE DRAWINGS OR FOUND DURING CONSTRUCTION. IF A PROPERTY CORNER OR MONUMENT IS DESTROYED OR DISTURBED, THE CONTRACTOR WILL HAVE IT REPLACED AND CERTIFIED BY A PROFESSIONAL SURVEYOR AND MAPPER REGISTERED IN THE STATE OF FLORIDA. ALL COSTS FOR PRESERVING, REPLACING AND CERTIFYING PROPERTY CORNERS AND MONUMENTS WILL BE INCLUDED IN THE PAY ITEM FOR MOBILIZATION.
- ANY NATIONAL GEODETIC SURVEY MONUMENT WITHIN THE LIMITS OF CONSTRUCTION MUST BE PROTECTED. IF IN DANGER OF DAMAGE. THE CONTRACTOR SHALL IMMEDIATELY NOTIFY THE ENGINEER AND:

FDEP, BUREAU OF SURVEY AND MAPPING, MS 100 3900 COMMONWEALTH BLVD. TALLAHASSEE, FLORIDA 32399 850-245-2555 (OFFICE) 850-245-2572 (FAX)

THE CONTRACTOR IS RESPONSIBLE FOR THE PROTECTION OF ALL UTILITIES. THE INFORMATION SHOWN ON THESE DRAWINGS CONCERNING TYPE AND LOCATION OF UNDERGROUND AND OTHER UTILITIES IS BASED ON INFORMATION PROVIDED BY THE UTILITY OWNERS, AVAILABLE RECORDS, AND SURVEYED FIELD INFORMATION. THE INFORMATION MAY NOT REFLECT ACTUAL CONDITIONS, INCLUDE ALL UTILITIES IN THE AREA, EITHER IN SERVICE OR ABANDONED, OR SHOW THE UTILITIES IN THE CORRECT HORIZONTAL OR VERTICAL LOCATIONS. THE CONTRACTOR SHALL MAKE HIS OWN DETERMINATION AS TO THE TYPE AND LOCATION OF UTILITIES AS NECESSARY TO ESTABLISH THEIR LOCATIONS AND AVOID DAMAGE. THE FOLLOWING UTILITIES. SHOULD BE CONTACTED FOR INFORMATION CONCERNING TYPE AND LOCATION OF THEIR FACILITIES. THE LIST MAY NOT INCLUDE ALL UTILITIES IN THE AREA.

SUNSHINE STATE ONE-CALL OF FLORIDA 811 OR 800-432-4770 (5 DAYS NOTIFICATION PRIOR TO CONSTRUCTION) CITY OF TALLAHASSEE/ELECTRICAL UTILITY 850-891-5091 CITY OF TALLAHASSEE/GAS UTILITY 850-891-5100 CITY OF TALLAHASSEE/WATER UTILITY 850-891-6107 CITY OF TALLAHASSEE/SEWER UTILITY 850-891-6107 COMCAST (CABLE TELEVISION) 850-574-4060 CENTURYLINK (TELEPHONE) 850-599-1502 AT&T (COMMUNICATIONS) 850-242-9087 SOUTHERN LIGHT (COMMUNICATIONS) 251-662-1170

- PRIOR TO ANY SCHEDULED INTERRUPTION OF UTILITY SERVICE, THE 9. CONTRACTOR SHALL COORDINATE SUCH INTERRUPTION WITH THE UTILITY PROVIDER AND SHALL PROVIDE A MINIMUM 24-HOUR NOTICE TO THE AFFECTED PARTIES. IN THE CASE OF A WATER MAIN SHUT DOWN, A MINIMUM 24-HOUR NOTICE ALSO SHALL BE PROVIDED TO THE TALLAHASSEE FIRE DEPARTMENT. THE CONTRACTOR SHALL NOTIFY THE ELECTRIC UTILITY A MINIMUM OF TWO WEEKS PRIOR TO CONSTRUCTION IN THE VICINITY OF THEIR FACILITIES.
- 10. THE CONTRACTOR SHALL NOTIFY THE GAS UTILITY (850-891-5100) A MINIMUM OF TWO WORKING DAYS PRIOR TO ANY EXCAVATION IN THE VICINITY OF GAS MAINS, AS REQUIRED BY CHAPTER 77-153 OF THE FLORIDA STATUTES. A GAS DEPARTMENT INSPECTOR WILL BE ON SITE WHEN WORK ACTIVITIES TAKE PLACE NEAR GAS MAINS. A MINIMUM OF 72 HOURS NOTICE SHALL BE PROVIDED FOR ANY REQUEST FOR GAS MAIN EXPOSURE OR ADJUSTMENT.
- 11. ALL UTILITIES IN CONFLICT WITH CONSTRUCTION ARE TO BE ADJUSTED OR RELOCATED BY OTHERS UNLESS NOTED OTHERWISE ON THE DRAWINGS OR DIRECTED BY THE ENGINEER
- 12. WHERE THE REQUIRED MINIMUM SEPARATION BETWEEN UTILITIES IS SPECIFIED, THE DISTANCE SHALL BE MEASURED FROM OUTSIDE OF PIPE TO OUTSIDE OF PIPE.
- 13. LIMITS OF CONSTRUCTION ARE DEFINED IN THE PLANS AND CONSIST OF ROADWAY RIGHTS-OF-WAY, CITY OF TALLAHASSEE PROPERTIES, DRAINAGE RIGHTS-OF-WAY, PERMANENT DRAINAGE AND/OR UTILITY EASEMENTS, AND TEMPORARY CONSTRUCTION EASEMENTS.
- 14. NO TRENCHES WILL BE ALLOWED TO REMAIN OPEN OVERNIGHT.
- 15. ALL EXISTING DRAINAGE STRUCTURES AND PIPES, PAVEMENT, SIDEWALKS, CURBS, ETC., WITHIN THE LIMITS OF CONSTRUCTION ARE TO REMAIN UNLESS OTHERWISE NOTED ON THE DRAWINGS OR DIRECTED BY THE ENGINEER. ALL DRAINAGE STRUCTURES, PIPES, PAVEMENT, SIDEWALKS, CURBS, ETC., THAT ARE TO REMAIN THAT ARE DAMAGED DURING CONSTRUCTION ARE THE RESPONSIBILITY OF THE CONTRACTOR AND IF DAMAGED DURING CONSTRUCTION SHALL BE REPAIRED OR REPLACED WITH THE SAME TYPE AND MATERIAL AT NO COST TO THE CITY.
- 16. ALL STORM MANHOLES OR STRUCTURES DESIGNATED TO BE ABANDONED IN PLACE SHALL BE REMOVED TO A MINIMUM OF THREE FEET BELOW GRADE AND FILLED WITH COMPACTED SAND
- 17. EXISTING CONCRETE AND ASPHALTIC CONCRETE DRIVEWAYS AND SIDEWALKS SHALL BE SAW-CUT AS REQUIRED FOR CONSTRUCTION.
- 18. ALL SIDEWALKS AND CURB RAMPS REMOVED DURING CONSTRUCTION SHALL BE RECONSTRUCTED TO MEET CURRENT ADA STANDARDS.
- 19. THE CONTRACTOR SHALL PUT FORTH EVERY REASONABLE EFFORT TO MINIMIZE DISRUPTION AND DISTURBANCE OF ADJACENT PROPERTIES. ACCESS BY PROPERTY OWNERS AND RESIDENTS TO THEIR PROPERTY SHALL BE MAINTAINED AT ALL TIMES, AND ANY BARRICADING OF ACCESS MUST BE COORDINATED WITH THE AFFECTED PROPERTY OWNERS AND RESIDENTS
- 20. ALL FENCES IN CONFLICT WITH CONSTRUCTION SHALL BE REMOVED AND REPLACED IN THEIR ORIGINAL LOCATIONS OR IN OTHER LOCATIONS AS DIRECTED BY THE ENGINEER. THE CONTRACTOR MAY, AT HIS OPTION, USE NEW FENCING MATERIAL OF THE SAME TYPE THAT WAS REMOVED OR REUSE THE FENCING MATERIAL THAT WAS REMOVED IF IT IS UNDAMAGED BY CONSTRUCTION ACTIVITIES. ALL FENCES DAMAGED BY CONSTRUCTION ACTIVITIES ARE TO BE REPLACED WITH NEW FENCING MATERIAL OF THE SAME TYPE THAT WAS REMOVED.
- 21. THE CONTRACTOR SHALL EXERCISE DUE CARE IN THE REMOVAL OF EXISTING FENCES TO MAINTAIN SECURITY AT THE AFFECTED PROPERTIES AND TO ENSURE THE SAFETY OF PETS, ANIMALS AND CHILDREN, IF IN THE OPINION OF THE ENGINEER, REMOVAL OF A FENCE WILL RESULT IN AN UNACCEPTABLE REDUCTION IN SECURITY OR SAFETY, THE CONTRACTOR SHALL INSTALL A TEMPORARY FENCE AS DIRECTED BY THE ENGINEER

PRIOR TO REMOVAL OF THE EXISTING FENCE. THE TEMPORARY FENCE SHALL REMAIN IN PLACE UNTIL THE PERMANENT FENCE IS INSTALLED

10. THE CON

7. ALL TYPE

8. ALL GRAT

2.

3.

4.

5.

6.

- 22. THE CONTRACTOR IS RESPONSIBLE FOR THE PROTECTION OF ALL TREES AND LANDSCAPING ON ADJACENT PROPERTIES, AND WILL BE SOLELY LIABLE FOR DAMAGE TO VEGETATION ON PROPERTIES ADJACENT TO CONSTRUCTION WORK ZONES. ALL TREES WITHIN THE LIMITS OF CONSTRUCTION THAT ARE NOT IDENTIFIED ON THE PLANS TO BE REMOVED SHALL BE PROTECTED TO THE MAXIMUM EXTENT PRACTICABLE. TREE PROTECTION BARRICADES SHALL BE INSTALLED AND MAINTAINED AROUND ALL TREES THAT ARE TO BE PROTECTED AS SHOWN ON THE DRAWINGS OR AS DIRECTED BY THE ENGINEER.
- 23. THE CONTRACTOR SHALL NOT DISTURB GRASSING OR LANDSCAPING OUTSIDE CONSTRUCTION WORK ZONES. THE CONTRACTOR SHALL BE SOLELY LIABLE FOR DAMAGE TO VEGETATION OUTSIDE CONSTRUCTION WORK ZONES AND SHALL RESTORE AT NO COST TO THE CITY ANY AREAS THAT ARE DAMAGED INCLUDING AREAS WITHIN THE LIMITS OF CONSTRUCTION OR ON ADJACENT PROPERTIES USING, TO THE EXTENT PRACTICABLE, THE SAME TYPES AND SIZES OF PLANT MATERIAL THAT EXISTED PRIOR TO CONSTRUCTION.
- 24. THE LOCATION AND CONSTRUCTION OF MAILBOXES SHALL BE IN CONFORMANCE WITH THE RULES AND REGULATIONS OF THE UNITED STATES POSTAL SERVICE. WHEN A MAILBOX IN CONFLICT WITH CONSTRUCTION IS REMOVED. THE CONTRACTOR SHALL FURNISH AND INSTALL A TEMPORARY MAILBOX AND SHALL MAINTAIN THE TEMPORARY MAILBOX UNTIL A NEW MAILBOX IS INSTALLED. THE CONTRACTOR SHALL CONSTRUCT A NEW MAILBOX TO MATCH, AS CLOSE AS PRACTICABLE, THE LOCATION, TYPE, SIZE, MATERIAL, AND COLOR OF THE ORIGINAL MAILBOX. IN LIEU OF CONSTRUCTING A NEW MAILBOX. THE EXISTING MAILBOX MAY BE REUSED IF IT MEETS THE RULES AND REGULATIONS OF THE UNITED STATES POSTAL SERVICE AND IS FUNCTIONALLY SOUND.
- 25. DISTURBED AREAS SHALL BE COMPACTED (AT A MINIMUM) EQUAL TO ADJACENT UNDISTURBED GROUND EXCEPT WHEN OTHERWISE SPECIFIED.
- 26. PROPERTIES ADJACENT TO WORK ZONES SHALL BE GRADED TO DRAIN WITHIN THE LIMITS OF CONSTRUCTION.
- 27. ALL DISTURBED AREAS WITHIN CONSTRUCTION WORK ZONES ARE TO BE GRASSED EXCEPT FOR AREAS THAT ARE LANDSCAPED, PAVED, OR BELOW NORMAL WATER LEVEL. EXISTING GRASSED AREAS SHALL BE REPLANTED WITH SOD OF THE SAME GRASS TYPE AS EXISTING, UNLESS OTHERWISE SHOWN ON THE PLANS OR DIRECTED BY THE ENGINEER. CENTIPEDE SOD WILL BE USED FOR DISTURBED AREAS NOT CURRENTLY GRASSED. REINFORCEMENT MAT SHALL BE INSTALLED BENEATH SOD PLACED ON SLOPES OF 2H:1V OR STEEPER, AND THE SOD SHALL BE STAPLED. COSTS FOR REINFORCEMENT MAT, STAPLING, FERTILIZING, AND WATERING SHALL BE INCLUDED IN THE UNIT PRICE OF THE PAY ITEM FOR PERFORMANCE TURE.
- 28. PRIOR TO REQUESTING A FINAL INSPECTION, THE CONTRACTOR SHALL PREPARE AND SUBMIT TO THE ENGINEER FOUR COMPLETE SETS OF CERTIFIED AS-BUILT RECORD DRAWINGS AND TWO COPIES OF THE DIGITAL FILES ON CD-ROM DISKS.

SUPPLEMENTAL GENERAL NOTES:

- CITY OF TALLAHASSEE SURVEYING PROVIDED THE TOPOGRAPHY, 1. BENCHMARKS, RIGHTS-OF-WAY AND UTILITY LOCATION INFORMATION SHOWN ON THE CONSTRUCTION DRAWINGS. ELEVATIONS ARE BASED ON NORTH AMERICAN VERTICAL DATUM OF 1988 (NAVD 88).
- THE CONTRACTOR SHALL PROTECT AND MAINTAIN ALL VALVE BOXES ON 2. GAS AND WATER MAINS WITHIN THE LIMITS OF CONSTRUCTION THAT ARE TO REMAIN IN SERVICE. PRIOR TO COMPLETION OF CONSTRUCTION, THE CONTRACTOR SHALL ADJUST ALL VALVE BOXES WITHIN CONSTRUCTION AREAS SO THE TOPS ARE FLUSH WITH FINISHED PAVEMENT OR WITH FINISHED GRADE IN UNPAVED AREAS.
- 3. ALL PUMPS USED FOR DEWATERING AND BYPASS PUMPING WILL BE SCREENED FROM RESIDENTIAL VIEW AND ENCLOSED TO REDUCE NOISE DURING OPERATION. AT NO TIME SHALL PUMPS BE PLACED WITHIN A RESIDENTIAL YARD OR 50 FEET OF A HOME WITHOUT APPROVAL FROM THE CITY. PAYMENT FOR SCREENING AND ENCLOSURE SHALL BE INCLUDED IN THE COST FOR CLEARING AND GRUBBING.

SUPPLEMENTAL GENERAL NOTES - STORMWATER CONSTRUCTION:

ALL NEW OR REPLACEMENT STORM DRAINS OR CULVERTS SHALL BE 1. CLASS III STEEL REINFORCED CONCRETE PIPE IN ACCORDANCE WITH STANDARD SPECIFICATION 449-4 OR FDOT APPROVED POLYPROPYLENE PIPE UNLESS NOTED OTHERWISE ON THE DRAWINGS. WHEN THE PLANS DESIGNATE A TYPE OF PIPE. THE CONTRACTOR MAY USE ONLY THE TYPE DESIGNATED. THE CONTRACTOR SHALL NOT USE A TYPE OF PIPE NOT

DESIGNATED ON THE DRAWINGS WITHOUT WRITTEN APPROVAL FROM THE ENGINEER. ALL PIPES SHALL BE CUT FLUSH WITH INSIDE OF DRAINAGE STRUCTURE.	ENGINEER OF RECORD LARE FULOS, F.E. Eldaw, M.C. 2222 Mangon Gene Cicla Saline 222 Falinasses, F. 2203 P.E. No. 5335 F.E. No. 5335
ALL REINFORCED CONCRETE PIPE SHALL BE INSTALLED USING SELECT BEDDING MATERIAL TO PROVIDE A FOUR-INCH MINIMUM DEPTH FOUNDATION BENEATH THE BARREL OF THE PIPE AND FOR BACKFILL UP TO THE SPRINGLINE (CENTER) OF THE PIPE. BACKFILL AROUND POLYPROPYLENE PIPE SHALL BE IN ACCORDANCE WITH THE MANUFACTURER'S SPECIFICATIONS.	ENGINEER LAKE P. LAKE
ALL JOINTS OF CONCRETE PIPES, CULVERTS, AND STORM SEWERS SHALL HAVE A FILTER FABRIC JACKET AS DETAILED ON STANDARD INDEX NO. 280, UNLESS NOTED OTHERWISE ON THE DRAWINGS OR DIRECTED BY THE ENGINEER.	
ALL PIPE CULVERTS AND STORM SEWERS 48-INCHES OR LESS IN DIAMETER SHALL BE VIDEO TAPED IN ACCORDANCE WITH SECTION 430-4.8 OF THE STANDARD SPECIFICATIONS UNLESS OTHERWISE DIRECTED BY THE ENGINEER.	
ALL CURB INLETS, DITCH BOTTOM INLETS, AND MANHOLES SHALL HAVE TRAFFIC BEARING FRAMES AND COVERS OR GRATES MEETING HS-20 LOADING REQUIREMENTS UNLESS OTHERWISE SHOWN ON THE PLANS.	
ALL STORM DRAIN COVERS SHALL BE TYPE USF TJ (U.S. FOUNDRY NO. 8017195), NPR15-728 (EJ GROUP COVER NO. 3062A2), OR APPROVED EQUAL.	ORIGINAL REVISIONS: 3 5 5
ALL TYPE J STRUCTURE BOTTOMS SHALL HAVE A MINIMUM 6'-0" WALL HEIGHT WHEN POSSIBLE.	(0
ALL GRATES SHALL BE CHAINED AND LOCKED IN ACCORDANCE WITH STANDARD INDEX NO. 201. COST OF EYEBOLTS AND CHAIN SHALL BE INCLUDED IN THE CONTRACT UNIT PRICE FOR THE STRUCTURES.	NOTES
UTILITIES IN CONFLICT WITH THE INSTALLATION OF A NEW STORM DRAIN ARE TO BE ADJUSTED OR RELOCATED TO ELIMINATE THE CONFLICT. IF THE CONFLICT CANNOT BE REASONABLY AVOIDED, A CONFLICT STRUCTURE WITH ACCESS SHALL BE CONSTRUCTED IN ACCORDANCE WITH STANDARD INDEX NO. 307 WITH THE EXCEPTION THAT FOR UTILITY CONFLICT CONDITION II (PRESSURE OR FLUID CARRIER INSTALLATIONS), A CARRIER PIPE IS NOT REQUIRED IF DUCTILE IRON PIPE IS USED FOR THE UTILITY AND NO PIPE JOINTS ARE LOCATED WITHIN THE CONFLICT STRUCTURE.	GENERAL
"NOTCHING" OF A STORM DRAIN PIPE OR STRUCTURE TO ACCOMMODATE A UTILITY SHALL NOT BE ALLOWED. NO UTILITY SHALL BE INSTALLED THROUGH ANY PORTION OF A STORM DRAIN PIPE WITHOUT A CONFLICT STRUCTURE.	N PARK EMENTS
THE CONTRACTOR SHALL EXCERCISE CAUTION WHILE REMOVING EXISTING LANDSCAPING, FENCES, DECORATIVE WALLS, AND OTHER OWNER-INSTALLED IMPROVEMENTS WITHIN THE LMITS OF CONSTRUCTION. THE CONTRACTOR SHALL STOCKPILE THE REMOVED MATERIALS IN A NEAT AND ORDERLY MANNER AT A LOCATION AGREEABLE TO THE PROPERTY OWNER.	project BRECKENRIDGE ON DRAINAGE IMPROV
	Engineering (Lithites, Transportation, and Water 2822 Remington Green Cir., Suite 202 PHONE. (850) 383-0400 TALLANSSEE, FLORENA 32308 Www.eutawine.com Certificate of Authorization #9961
	DRAWN DESIGNED CHECKED QC

GENERAL PAY ITEM NOTES:

- 1. NO SEPARATE PAYMENT WILL BE MADE FOR DEWATERING. THE COSTS FOR DEWATERING SHALL BE INCLUDED IN THE UNIT PRICES FOR ANY ITEMS REQUIRING DEWATERING.
- 2. NO SEPARATE PAYMENT WILL BE MADE FOR FILTER FABRIC. THE COSTS FOR FILTER FABRIC SHALL BE INCLUDED IN THE UNIT PRICES FOR ANY ITEMS REQUIRING FILTER FABRIC.
- 3. NO SEPARATE PAYMENT WILL BE MADE FOR VIDEO TAPING PIPE CULVERTS. THE COSTS FOR VIDEO TAPING ARE INCLUDED IN THE UNIT PRICES FOR PIPE CULVERT.
- 4. ADDITIONAL QUANTITIES OF EROSION CONTROL AND/OR TREE PROTECTION ITEMS MAY BE NECESSARY AS DETERMINED DURING CONSTRUCTION BY THE CONTRACTOR, THE ENVIRONMENTAL INSPECTOR, OR BY THE ENGINEER AND MUST BE APPROVED BY THE ENGINEER.
- 5. UNIT PRICES FOR PIPES, CULVERTS, SEWER PIPE AND WATER MAIN INCLUDE THE COSTS FOR FURNISHING, INSTALLING, MAINTAINING AND REMOVAL OF 1.5 INCH MINIMUM THICKNESS OF ASPHALT PAVEMENT MILLINGS OR FINE TYPE SP ASPHALTIC CONCRETE AT THE GROUND SURFACE OF ALL PIPE AND BOX CULVERT TRENCHES IN PAVED AREAS FOR THE PURPOSE OF SEDIMENT AND EROSION CONTROL UNTIL THE FINAL PAVEMENT IS PLACED.

STORMWATER PAY ITEM NOTES:

101-1: MOBILIZATION

THE UNIT PRICE ALSO INCLUDES ALL COSTS FOR PREPARATION OF AN APPROVED CONSTRUCTION PROGRESS SCHEDULE, AN APPROVED EROSION CONTROL PLAN, AN APPROVED TRAFFIC CONTROL PLAN, AN APPROVED DEWATERING PLAN, THE PRECONSTRUCTION SURVEY, PREPARING AND SUBMITTING APPROVED SHOP DRAWINGS, AND FURNISHING, INSTALLING, AND REMOVING THE PROJECT SIGNS. THE UNIT PRICE ALSO INCLUDES THE COST OF ARBORIST MITIGATION AS DETAILED IN THE PLANS (SEE TREE PROTECTION AND EROSION CONTROL SHEETS)

102-1: MAINTENANCE OF TRAFFIC

THE UNIT PRICE CONSTITUTES FULL COMPENSATION FOR ALL LABOR AND MATERIALS REQUIRED TO IMPLEMENT THE APPROVED TRAFFIC CONTROL PLAN TO SAFELY MAINTAIN TRAFFIC AROUND OR THROUGH THE WORK ZONE NOT INCLUDED FOR PAYMENT UNDER OTHER RELATED PAY ITEMS, INCLUDING WARNING AND REGULATORY SIGNS, MESSAGE BOARDS, DRUMS, BARRICADES, CHANNELIZING DEVICES, TEMPORARY CONCRETE BARRIER, WARNING LIGHTS, FLAGGERS, BUSINESS ENTRANCE SIGNS, MAINTENANCE OF EXISTING DRIVEWAYS, TEMPORARY PAVEMENT, AND REMOVAL AND REINSTALLATION OF EXISTING SIGNS IN CONFLICT WITH CONSTRUCTION AS DIRECTED BY THE ENGINEER. NO ADJUSTMENTS WILL BE MADE TO THE CONTRACT PRICE FOR INCREASES IN CONTRACT TIME. THE UNIT PRICE ALSO INCLUDES THE COST OF WET WEATHER DRIVING SURFACES FOR THE DURATION OF THE PROJECT AND DUST CONTROL AS NEEDED AT ALL OTHER TIMES.

102-70: TEMPORARY BARRICADE FENCE (ORANGE) THE UNIT PRICE CONSTITUTES FULL COMPENSATION FOR ALL LABOR AND MATERIALS NECESSARY FOR THE INSTALLATION, MAINTENANCE, AND REMOVAL OF TEMPORARY BARRICADE FENCE. THIS ITEM IS TO BE USED FOR PEDESTRIAN SAFETY, TREE PROTECTION, OR AS DIRECTED BY THE ENGINEER.

104-14: STORMWATER POLLUTION PREVENTION

THE UNIT PRICE CONSTITUTES FULL COMPENSATION FOR ALL LABOR AND MATERIALS NECESSARY FOR THE INSTALLATION AND MAINTENANCE OF EROSION AND SEDIMENT CONTROL DEVICES AS REQUIRED TO PREVENT THE OFF-SITE TRANSPORT OF SEDIMENT. INCLUDING SEDIMENT BARRIERS, SEDIMENT BASINS, AND CONTAINMENT SYSTEMS AS SHOWN ON THE PLANS AND/OR DESCRIBED IN THE STATE OF FLORIDA EROSION AND SEDIMENT CONTROL DESIGNER AND REVIEWER MANUAL. THE PRICE ALSO INCLUDES THE PERIODIC REMOVAL AND DISPOSAL OF ACCUMULATED SEDIMENT, AND REMOVAL AND DISPOSAL OFF-SITE OF EROSION AND SEDIMENT CONTROL MATERIALS, INCLUDING ROCK AND RUBBLE RIPRAP. AT COMPLETION OF CONSTRUCTION. FURNISHING AND PLACING SUITABLE MATERIAL AS REQUIRED TO FILL SEDIMENT SUMPS, ANY PERMITS AND FEES REQUIRED FOR OFF-SITE DISPOSAL, AND TURBIDITY MONITORING IN COMPLIANCE WITH THE ENVIRONMENTAL PERMITS.

110-1-1: CLEARING AND GRUBBING

THE UNIT PRICE ALSO INCLUDES REMOVAL AND DISPOSAL OF TREES, ASPHALT, BASE, SUB-BASE, CURBS, SIDEWALKS, DRIVEWAYS, DRAINAGE STRUCTURES, PIPES, FENCES, SANITARY SEWER PIPES & STRUCTURES, AND ALL OTHER STRUCTURES AND OBSTRUCTIONS NECESSARY TO BE REMOVED AND FOR WHICH OTHER ITEMS OF THE CONTRACT DO NOT SPECIFY THE REMOVAL THEREOF. PARTIAL PAYMENTS WILL BE BASED UPON THE ESTIMATED TOTAL VALUE OF WORK COMPLETED TO THE DATE OF THE ESTIMATE AS DETERMINED BY THE ENGINEER. ALL PARTIAL ESTIMATES AND PAYMENTS ARE SUBJECT TO CORRECTION IN SUBSEQUENT ESTIMATES AND PAYMENT. THE UNIT PRICE ALSO INCLUDES ALL COSTS FOR REMOVAL OF EXISTING FENCES AND RELOCATION OR REPLACEMENT WITH NEW FENCE OR WITH THE FENCING MATERIAL THAT WAS REMOVED IF IT IS UNDAMAGED, AND FOR THE RELOCATION OR REPLACEMENT OF MAILBOXES.

110-7-1: MAILBOX:

UNIT PRICE SHALL INCLUDE ALL COSTS TO MEET THE REQUIREMENTS OF THE GENERAL NOTES ON SHEET 3 (GENERAL NOTE 24) OF THE PLANS.

120-1 AND 120-6: REGULAR EXCAVATION AND EMBANKMENT FINAL PAY QUANTITY WILL BE PLAN QUANTITY WITH NO CONSIDERATION FOR SPECIFICATION TOLERANCES. THE UNIT PRICE ALSO INCLUDES ALL COSTS FOR TURBIDITY MONITORING IN COMPLIANCE WITH THE ENVIRONMENTAL PERMITS.

334-1-12: SUPERPAVE ASPHALTIC CONCRETE (2" THICK) THE UNIT PRICE SHALL INCLUDE THE ADJUSTMENT OF ALL EXISTING UTILITY FRAMES AND COVERS AND WALL WATER AND GAS VALVES WITHIN THE LIMITS OF CONSTRUCTION.

425-1-521, 425-1-523, 425-1-541 425-1-553: DITCH BOTTOM INLETS UNLESS OTHERWISE NOTED IN THE PLANS, THE UNIT PRICES ALSO INCLUDE ALL COSTS FOR FURNISHING AND INSTALLING TRAFFIC BEARING GRATES MEETING HS-20 LOADING REQUIREMENTS. THE UNIT PRICES FOR DITCH BOTTOM INLETS WITH SLOTS ALSO INCLUDE ALL COSTS FOR FURNISHING AND INSTALLING 1 INCH DIAMETER POWDER COATED STEEL BARS CAST INTO THE STRUCTURES AS SHOWN IN THE PLANS. THE UNIT PRICE SHALL ALSO INCLUDE THE COST OF ALL MODIFIED TRAVERSABLE AND MODIFIED NON-TRAVERSABLE SLOTS.


425-2-61, 426-2-71, 425-2-91: MANHOLES AND JUNCTION BOXES UNLESS OTHERWISE NOTED IN THE PLANS, THE UNIT PRICES ALSO INCLUDE ALL COSTS FOR FURNISHING AND INSTALLING TWO-PIECE COVERS AND FRAMES WITH 3'-0" OPENINGS WHEN THE DEPTH OF THE STRUCTURE EXCEEDS 6'-0".


430-175-118, -124, -136, -148, -230: PIPE CULVERT, CONCRETE THE UNIT PRICES ALSO INCLUDE PAYMENT FOR SHEETING AND/OR SHORING, DEWATERING, FILTER FABRIC, FURNISHING, PLACING AND COMPACTING SELECT BEDDING MATERIAL, AND FURNISHING SELECT MATERIAL FOR BACKFILL WHEN SUITABLE MATERIAL IS NOT AVAILABLE ON SITE. UNIT PRICE ALSO INCLUDES THE COSTS OF REPLACEMENT OF ADJOINING FENCES IMPACTED BY CONSTRUCTION ACTIVITIES. CONTRACTOR SHALL COORDINATE WITH CITY ELECTRIC DEPARTMENT, CITY GAS DEPARTMENT, CITY WATER & SEWER DEPARTMENT, COMCAST CABLE, AND CENTURY LINK COMMUNICATIONS IN THE PROTECTION AND/OR RELOCATION OF THEIR FACILIITES. ALL COSTS ASSOCIATED WITH THESE REQUIREMENTS SHALL BE INCLUDED IN THE UNIT PRICE.


522-2: CONCRETE DRIVEWAY RECONSTRUCTION THE UNIT PRICES CONSTITUTES FULL PAYMENT FOR REMOVAL OF EXISTING CONCRETE, EXCAVATION, GRADING, FURNISHING AND INSTALLING 6" CONCRETE PAVEMENT TO RESTORE CONCRETE DRIVEWAYS AT LOCATIONS SHOWN IN THE PLANS.


570-1-2: PERFORMANCE TURF, SOD, CENTIPEDE AND ST. AUGUSTINE THE UNIT PRICES CONSTITUTE FULL COMPENSATION FOR ALL LABOR, MATERIALS, AND INCIDENTALS REQUIRED FOR ESTABLISHING A STAND OF GRASS BY SODDING IN ACCORDANCE WITH SECTION 570 OF THE STANDARD SPECIFICATIONS, INCLUDING FURNISHING AND PLACING SOD, PEGGING WHEN SPECIFIED IN THE PLANS, AND FURNISHING AND APPLYING FERTILIZER AND WATER. THE UNIT PRICES ALSO INCLUDE AND MAINTENANCE, INCLUDING LITTER REMOVAL AND MOWING UNTIL FINAL ACCEPTANCE.


ENGINEER OF RECORD LANE P. LUCAS, P.E. Eutaw, Inc.	2822 Reminipon Green Circle Sulte 20 Tallahassee, FL 32308 P.E. NO, 53936	Signature Date
ORIGINAL	- 0 n 4 o	
SHEET	PAY ITEM NOTES	
PROJECT	BRECKENRIDGE ON PARK DRAINAGE IMPROVEMENTS	
Eutow, Inc	Engineering Utilities, Transportation, and Water 2822 Remington Green Cir., Suite 202 PHONE. (850) 383-0400 TALLANASEE, FLORDA 22308 www.eutavine.com Certificate of Authonization #9061	
JOB N DRAWN DESIGN CHECK QC	I	

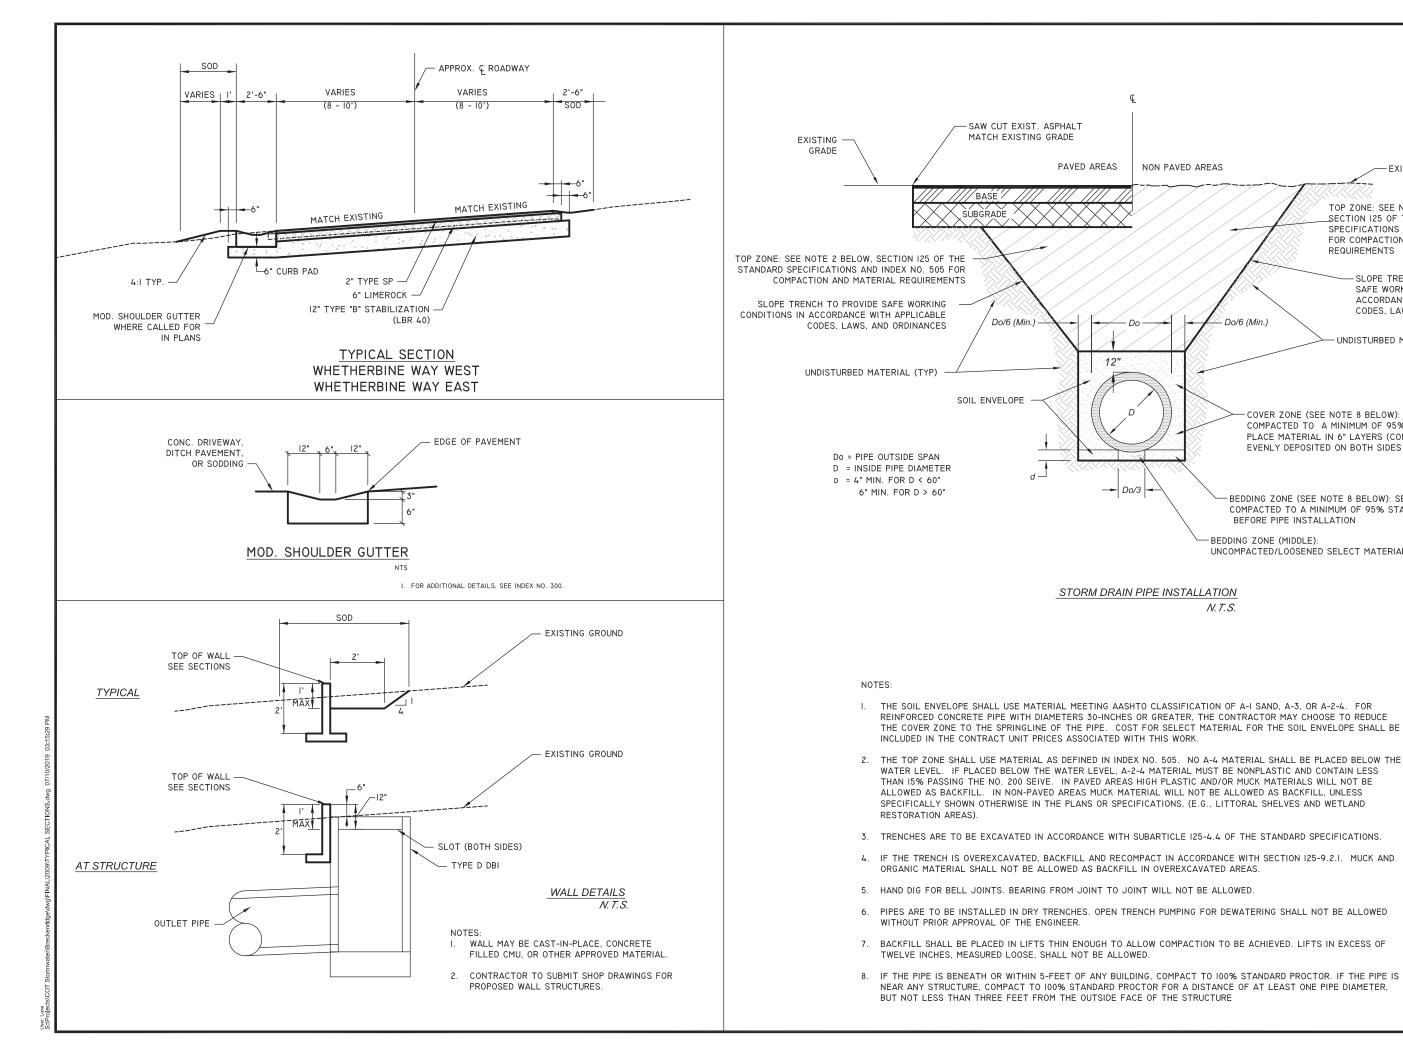


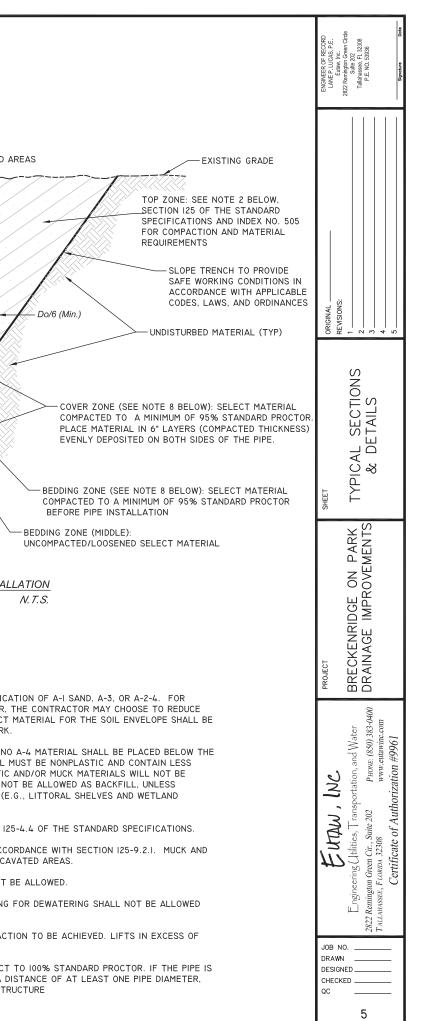

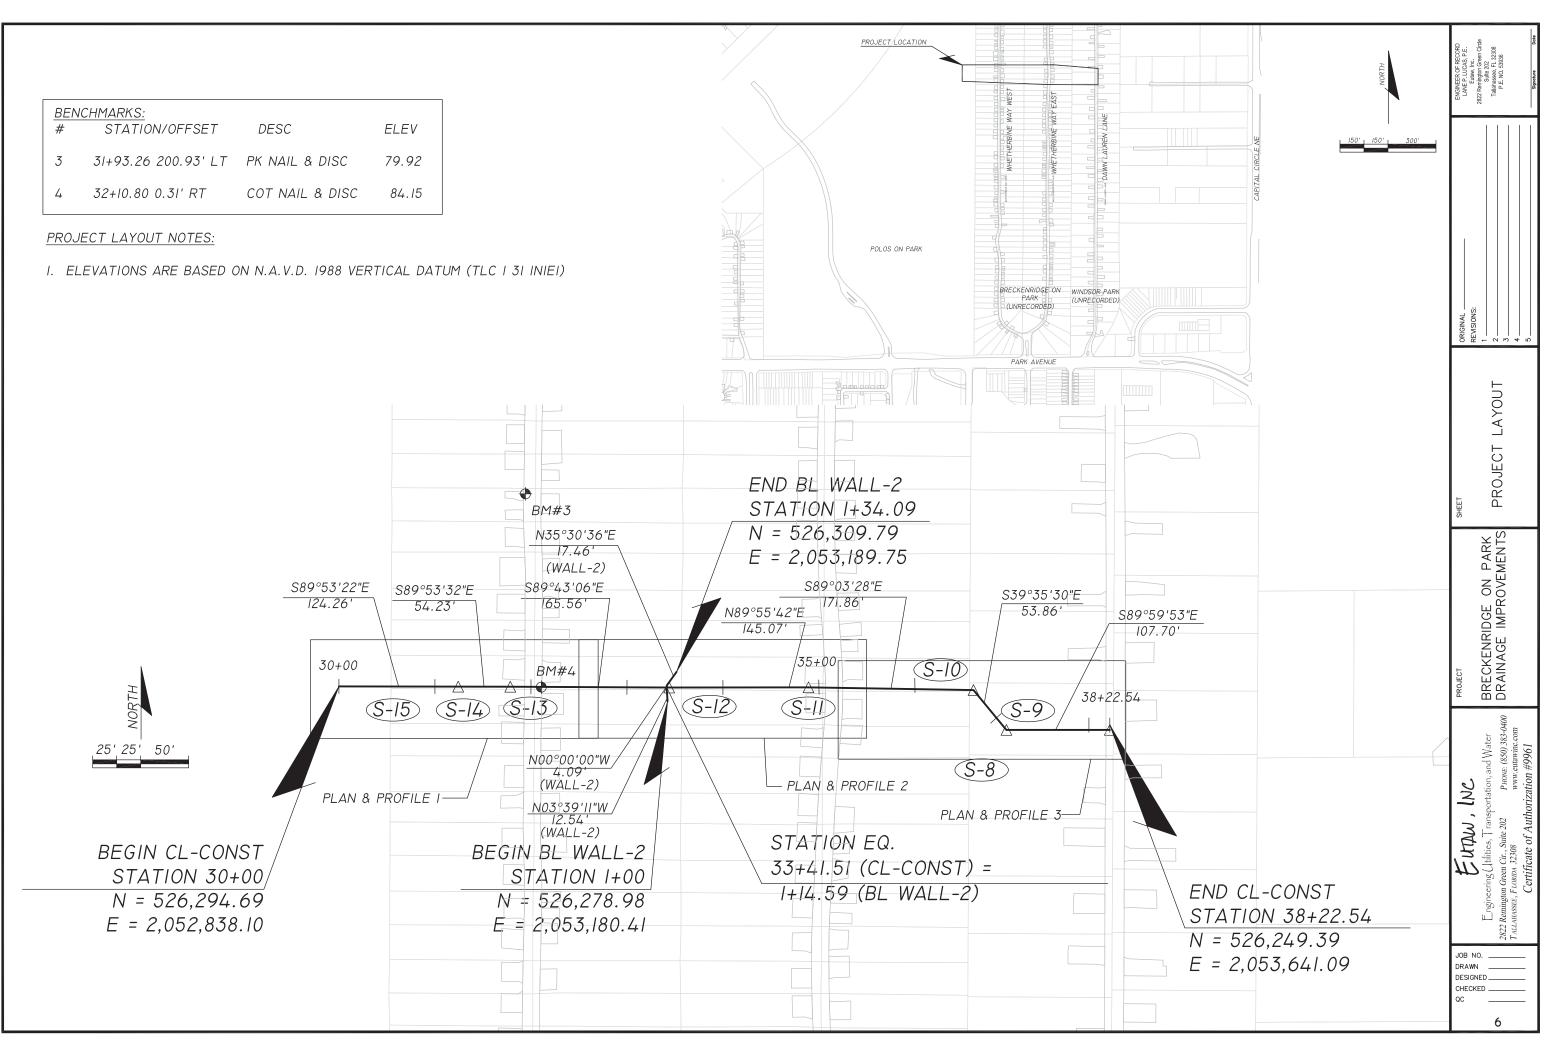

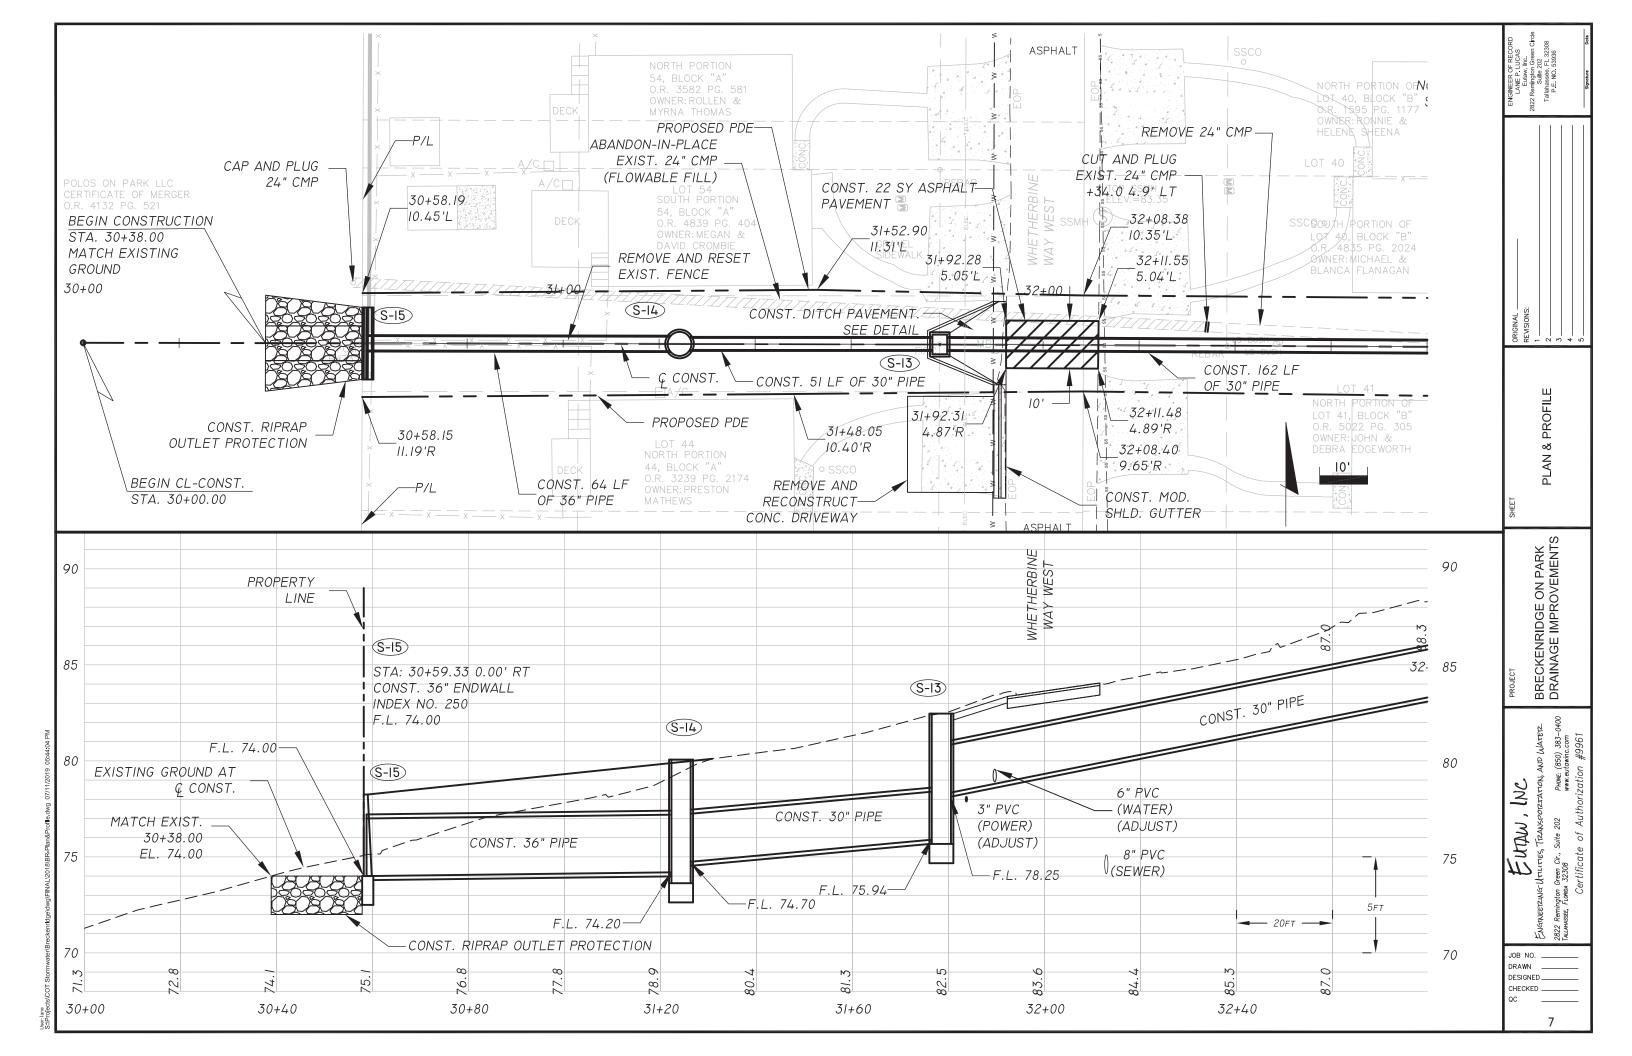


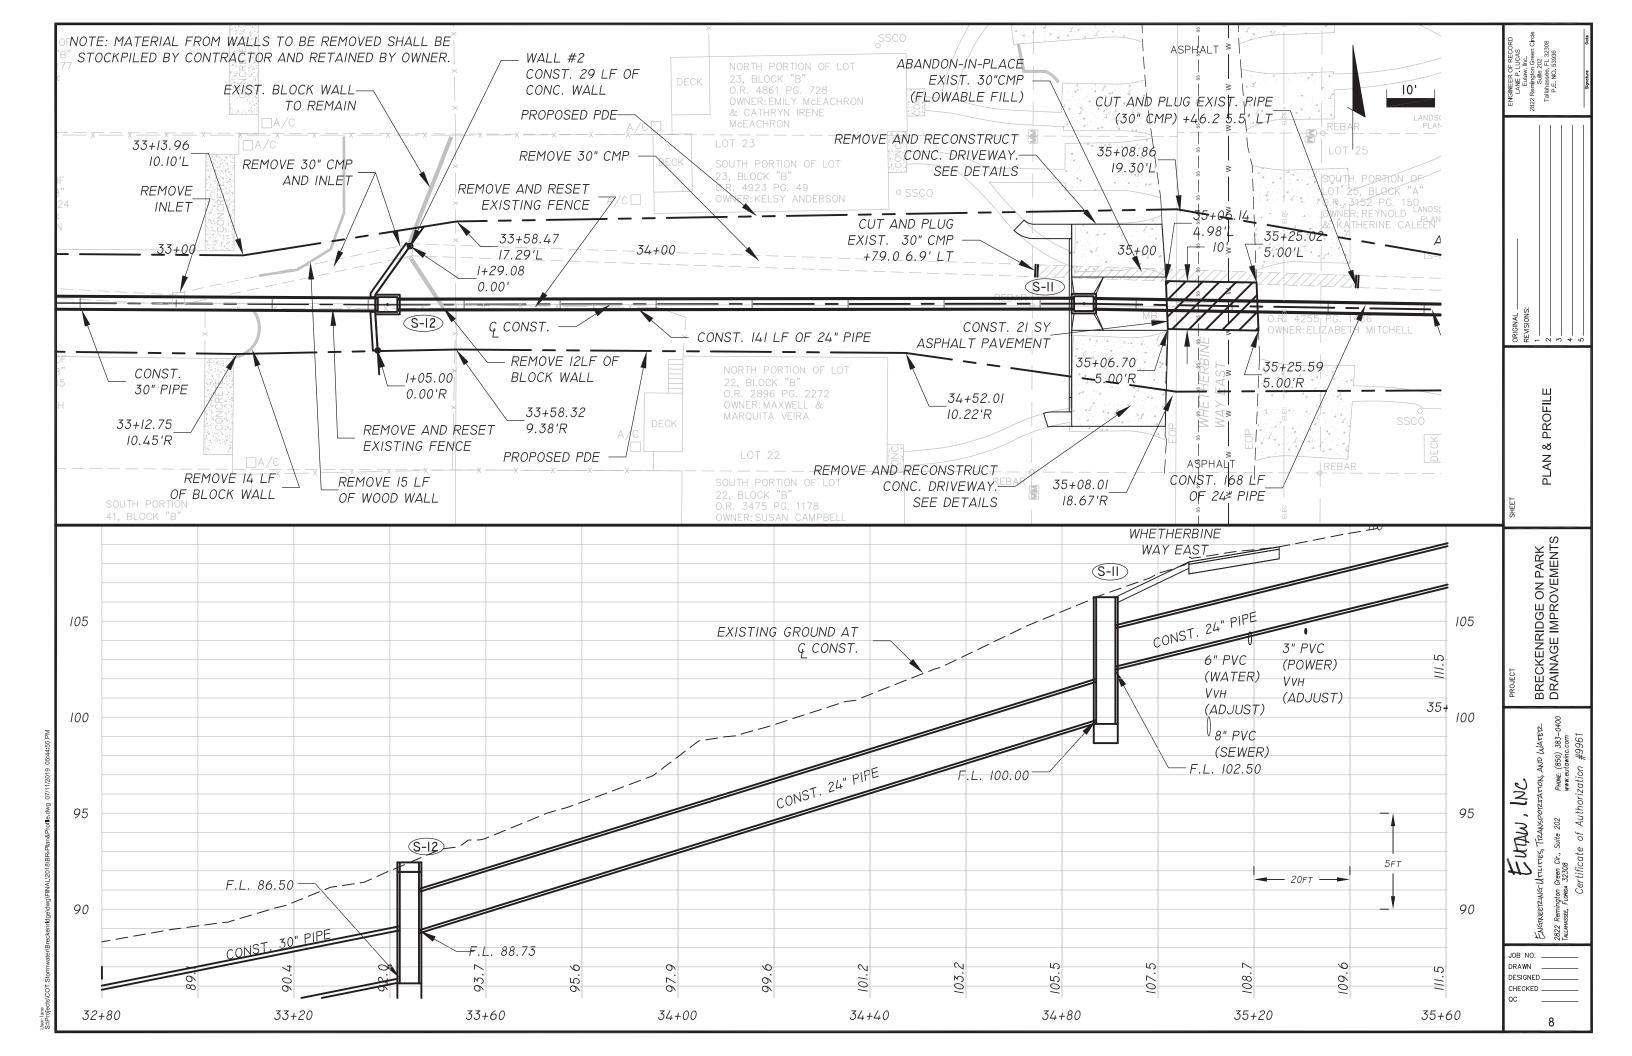

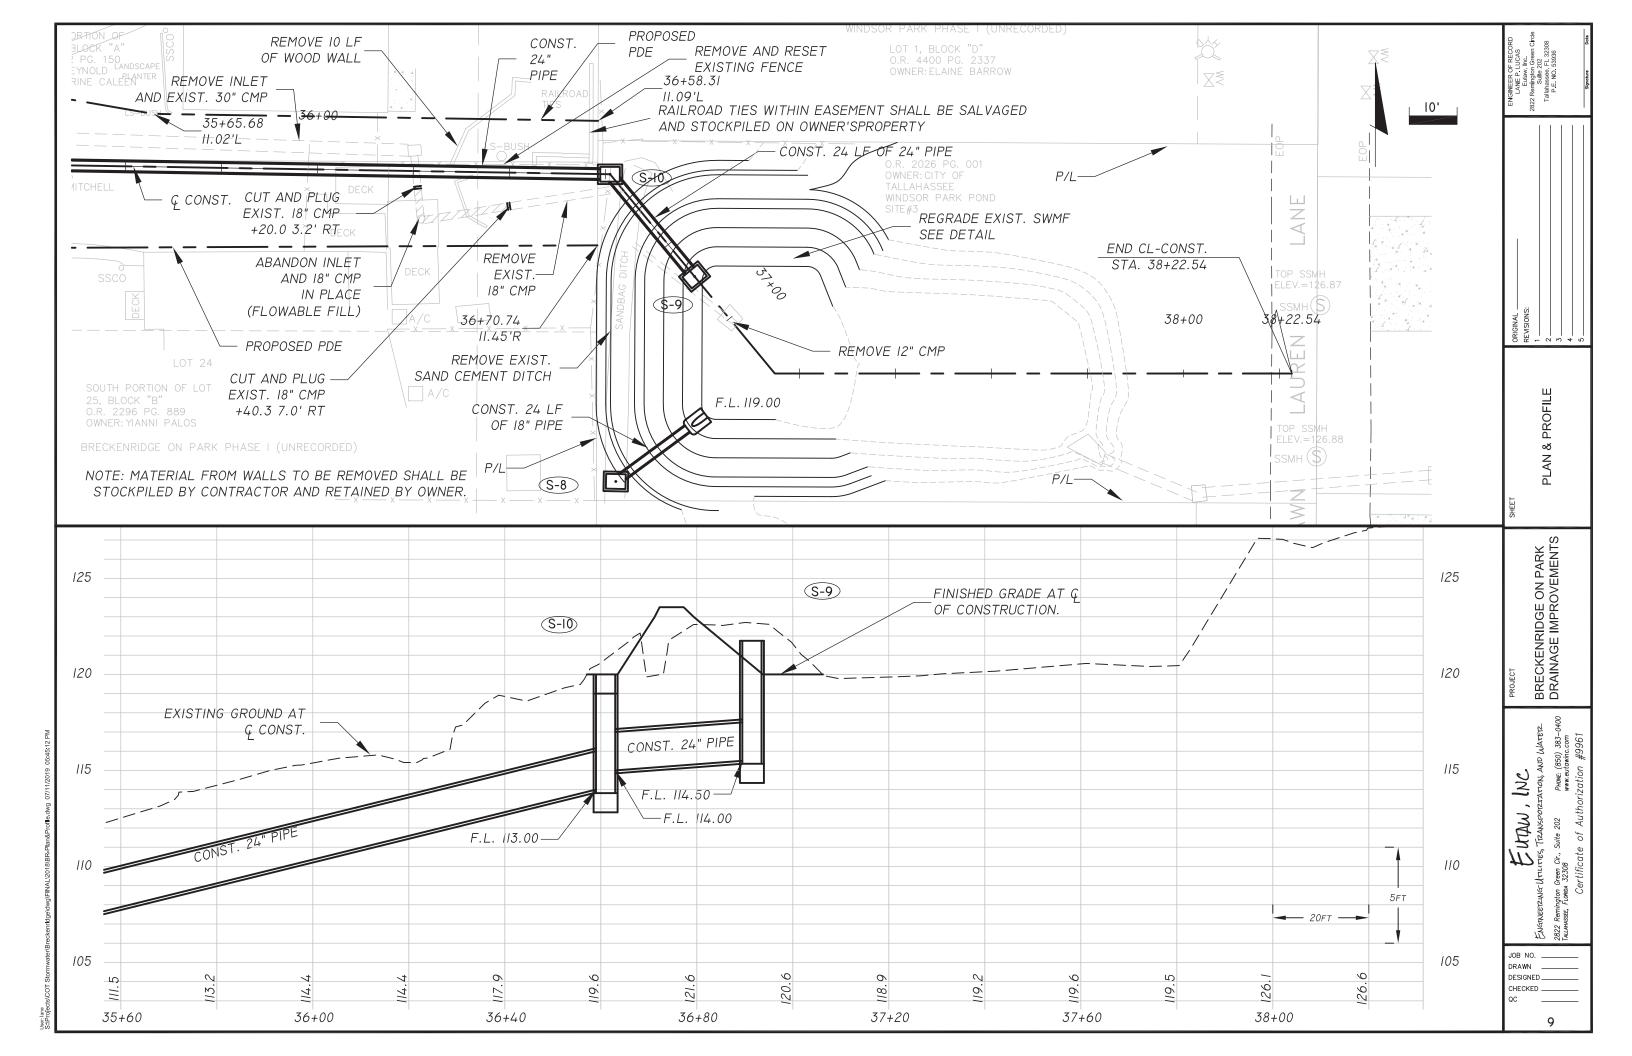


	31+78.49						
	51770.49				34+89.12		
S-13			(S-II)		J4707.1L		
STA: 31+78.49 0.00' RT	FROM S-12		STA: 34+89.12 0.		FROM S-ID		
CONST. DBI TYPE 'D'			CONST. DBI TYPE	'D'	FROM S-10		
WITH SLOT	∽ 30" PIPE		WITH SLOT				
INDEX NO. 232			INDEX NO. 232		M		
GRATE: 82.46			GRATE: 105.50		24" PIPE		
SLOT: 81.96 (AH)			SLOT: 104.92 (LT				
F.L. 78.25 (AH) 84		84	F.L. 102.50 (AH)	108		108	
F.L. 75.94 (BK) — —			F.L. 100.00 (BK)				
80		80		104		104	
76		76		100		100	DRAINAGE S
		, , ,		100		RETE DITCH PAVEM	IENT, I. ALTHOUG
						DETAILS	DRAINAGE S
	30" PIPE				24" PIPE		AVAILABLE
							FIELD COND
							THE ELEVAT
							TOPS SHOUL
	T0 (S-14)				T0 (S-12)		GROUND OR
						20	
-20	-10 0 10	20		-20	-10 0 10	20	
							20F
					33+44.05		
			(S-12)		55744.05		
	31+24.26						
			STA: 33+44.05 0.0				S-10
S-14	FROM S-I3		CONST. DBI TYPE		FROM S-ID		
STA: 31+24.26 0.00' RT			(J-BOTTOM, 5'X4')				STA: 36+60.9
CONST. MH TYPE J-8 (5')		WITH SLOT		M		CONST. DBI T WITH SLOT
INDEX NO. 200,201) M		INDEX NO. 232		24" PIPE		INDEX NO. 23
RIM: 80.07	30" PIPE		GRATE: 92.44	96		96	GRATE: 119.00
F.L. 74.70 (AH)			SLOT: 91.94 (LT &				SLOT: 118.00 (
F.L. 74.20 (BK) ⁸⁰		80	F.L. 88.73 (AH)	92 ~		92	F.L. 114.00 (R
			F.L. 86.50 (BK)				F.L. 113.00 (B)
76		76		88		88	
	\square						
72		72		84		84	
		12		04		04	
	36" PIPE				30" PIPE		
	T0 (S-15)						
					T0 (S-13)		
		20				20	
		20		-20	-10 0 10	20	
-20	-10 0 10	20					
-20		20					

	ENGINEER OF RECORD LANE F. UCAS Editav, Inc. 2822 Remigitor Green Cricle Suite 202 Tallahassee, FL 32308 P.E. NO. 53936 P.E. NO. 53936
RE NOTES: LEVATIONS OF THE TOPS OF RES ARE BASED ON THE BEST ATION, THEY MAY NOT MATCH INLET TOPS SHOULD BE SET TO ADJACENT CURBS. MANHOLE T TO MATCH THE FINISHED NT ELEVATIONS.	SHEET SHEET SHEET SHEET SHEET SHEET SHEENSIONS SHEENSIN
36+60.99 RT FROM (S-9)	PROJECT BRECKENRIDGE ON PARK DRAINAGE IMPROVEMENTS
124 120 120 116 116 112 122 120 120 120 120 120 120	Evenue Inc. INC Evenuereruwar Urrurres, Transporzatriou, AND Watere 2822 Remington Green Cir., Suite 202 PHONE (1850) 383-0400 Turunsse: Fignena 33309 Certificate of Authorization #9961
	JOB NO DRAWN DESIGNED CHECKED QC 10

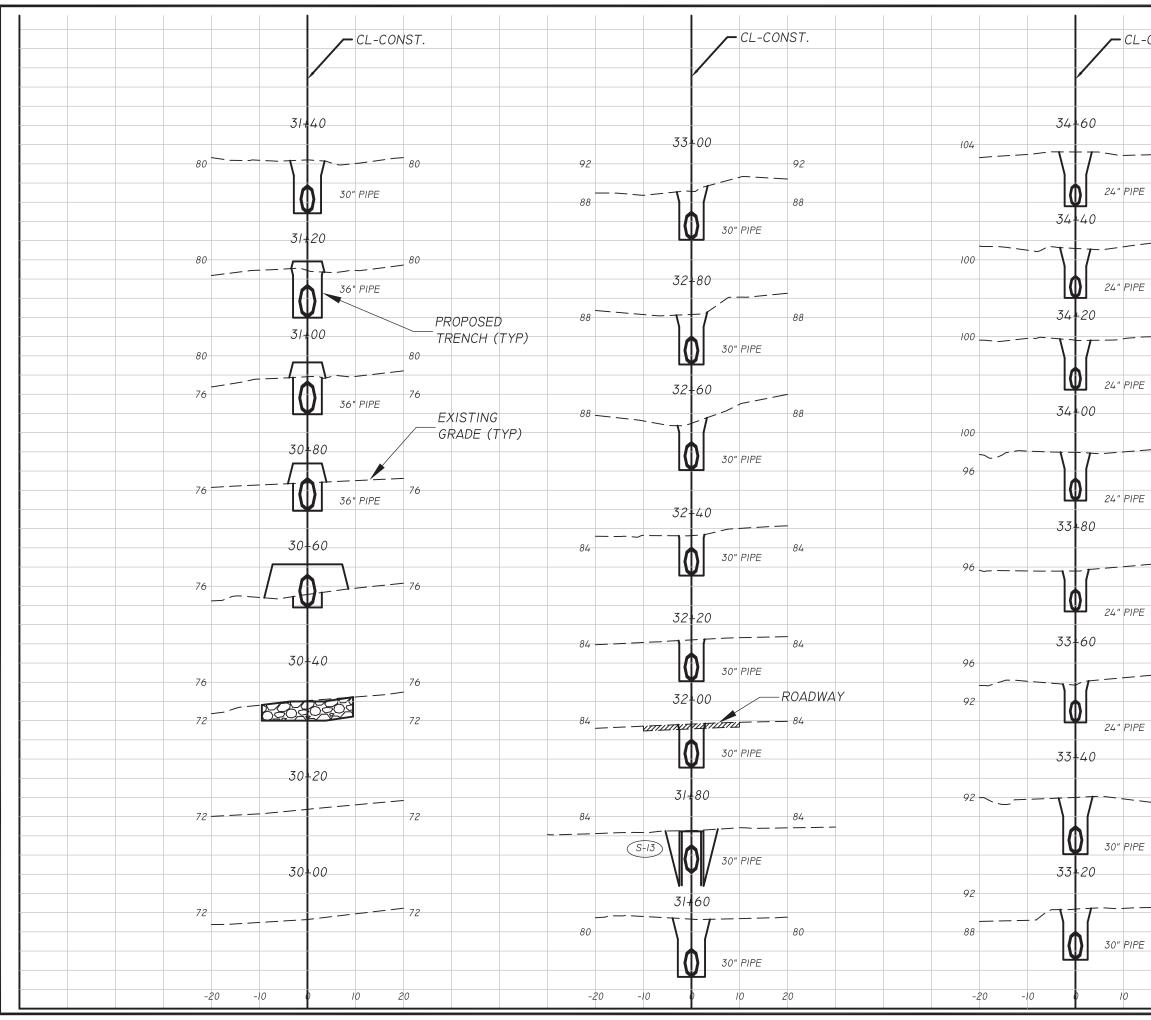


ects(COT Stormwater/Breckenridge)dwg/FINAL/2018/BR-Xsections.dwg 07/10/20


CONST.	ENGINEER OF RECORD LUNE F. LUCAS Eutaw, Inc. 2822 Ramigino Green Circle Sulle 202 P.E. NO. 53936 P.E. NO. 53936 B.E. NO. 53936 B.E. NO. 53936
	oRIGINAL REVISIONS: 1 2 3 5
	SHEET ARE RECTIONS CROSS SECTIONS 2.3.44.44.44.44.44.44.44.44.44.44.44.44.4
	PROJECT 51 BRECKENRIDGE ON PARK DRAINAGE IMPROVEMENTS
	EUTAUU , INC ENGRUGERZUGE UTULTES, TRANSPORZATTON, AND ULATERZ 2822 Remington Green Cir., Suite 202 PHAME. (850) 383-0400 TULUMASEE, FLOREN 32308 Certificate of Authorization #9961
20 IO FT	10B NO. JOB NO. DRAWN

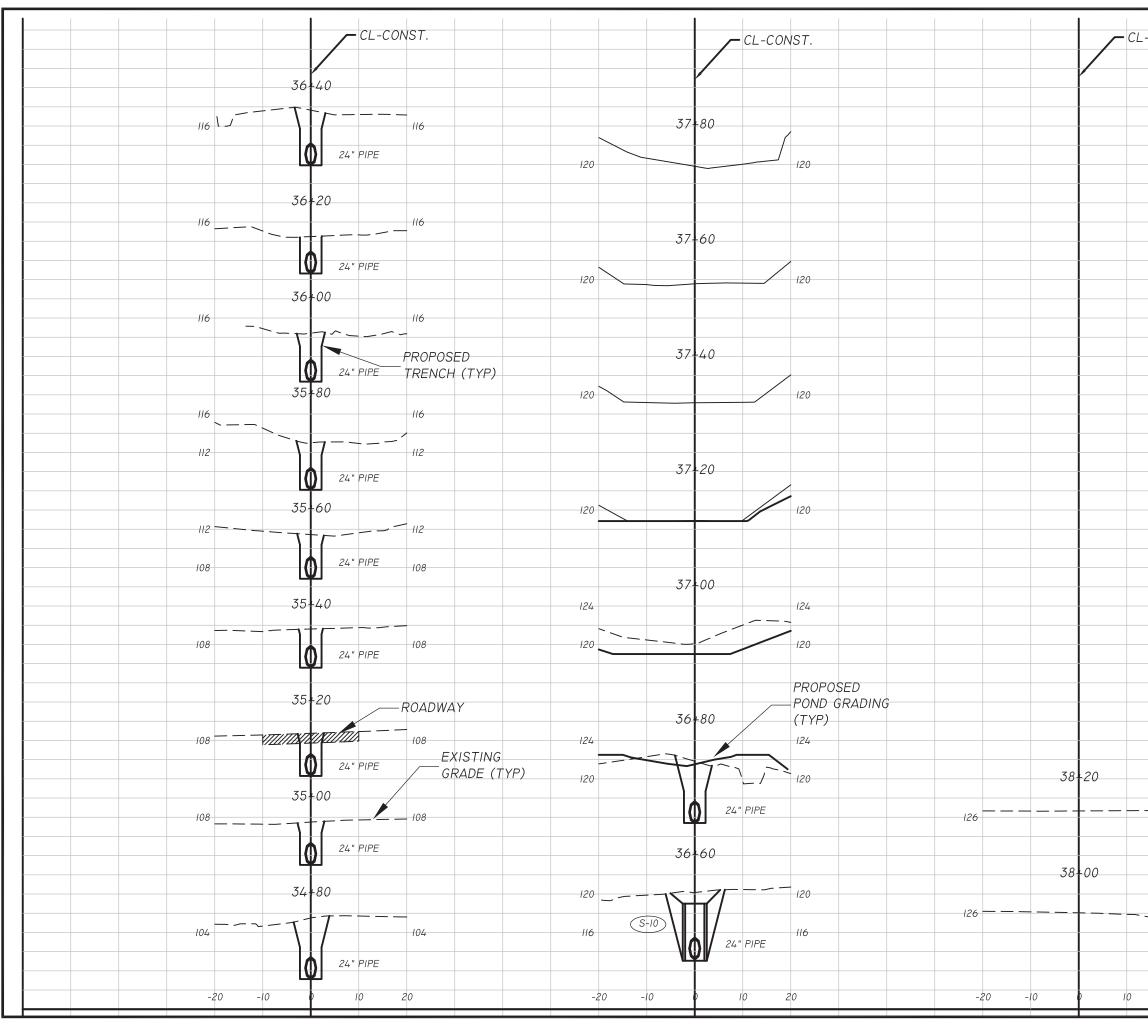



r lane Projects/COT StormwatenBreckenridge\dwg/FINAL\2018/BR•Xsections.dwg 07/10/2019 02-44:09 F

CONST.			LINNEECH DECONTRACTOR CONTRACTOR CONTRACTOR CONTRACTOR CONTRACTOR CONTRACTOR CONTRACTOR CONTRACTOR P.E. NO. 53396 Talmassee, L. NO. 53396 P.E. NO. 53396 P.E. NO. 53396 P.E. NO. 53396
			REVISIONS: 1
			CROSS SECTIONS
			BRECKENRIDGE ON PARK DRAINAGE IMPROVEMENTS
126		 	Evenuerung-Urturres, Transportararion, INC Evenuerrungton Green Cir., Suite 202 Prave: (850) 333-0400 Taurasses, Fignera 32308 Certificate of Authorization #9961
20	20	FT	IOB NO JRAWN JESIGNED CHECKED QC 12

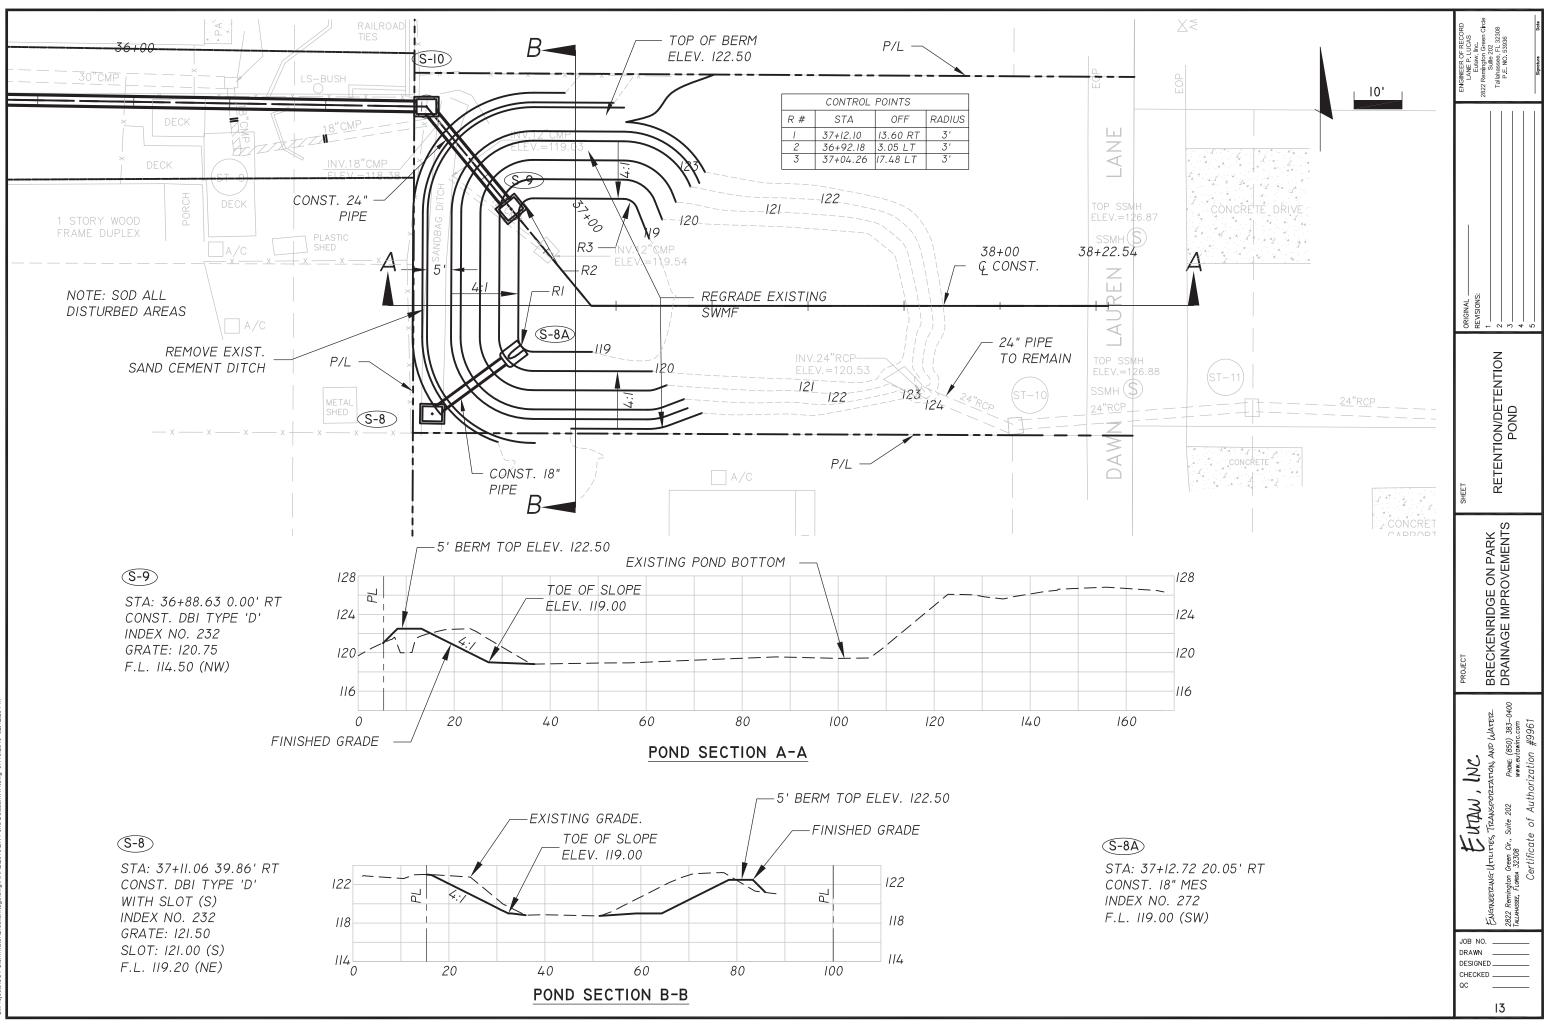


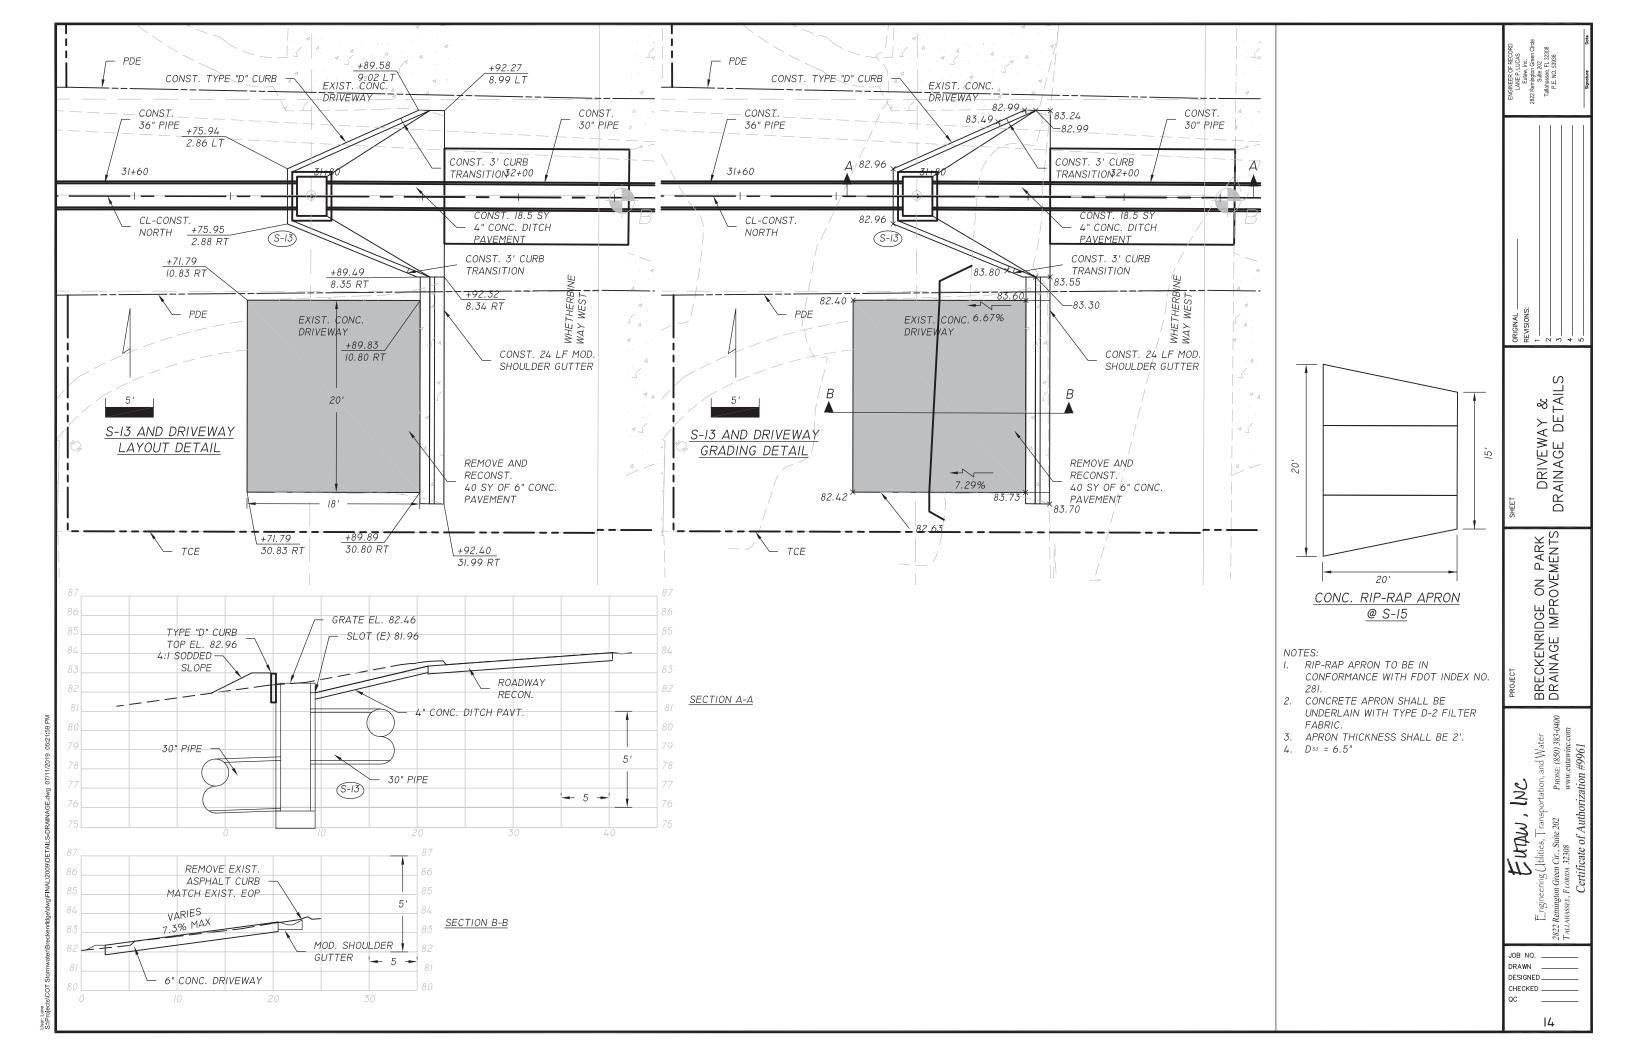


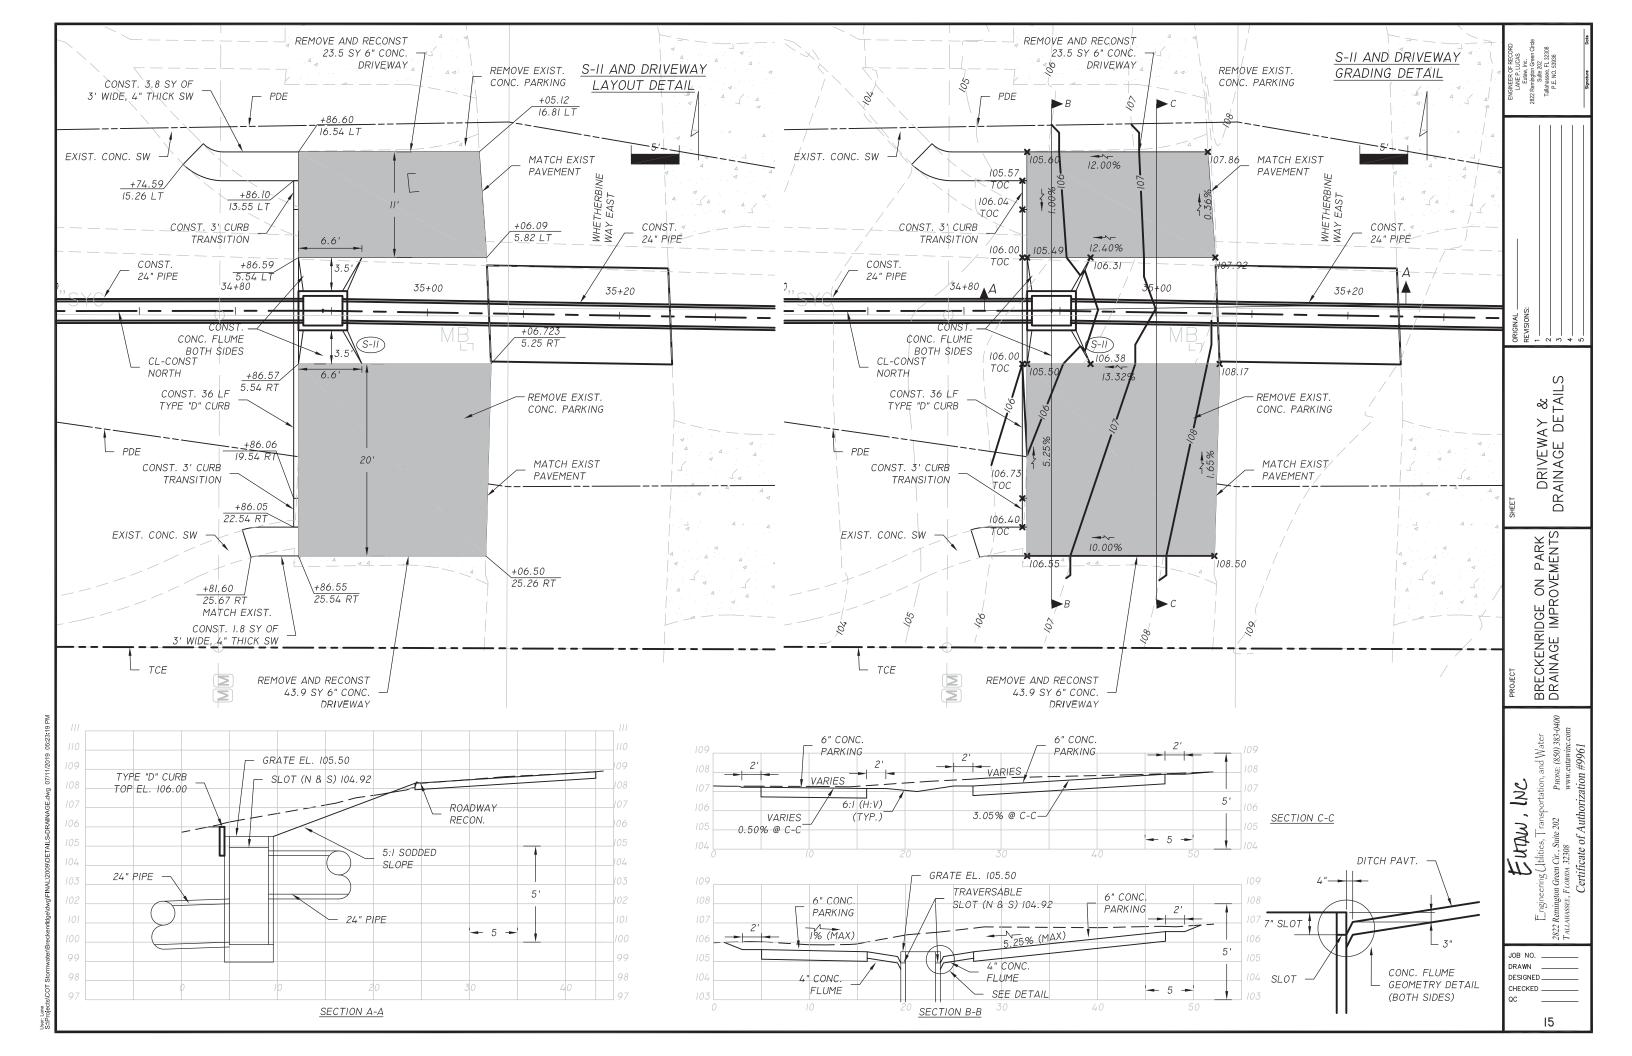


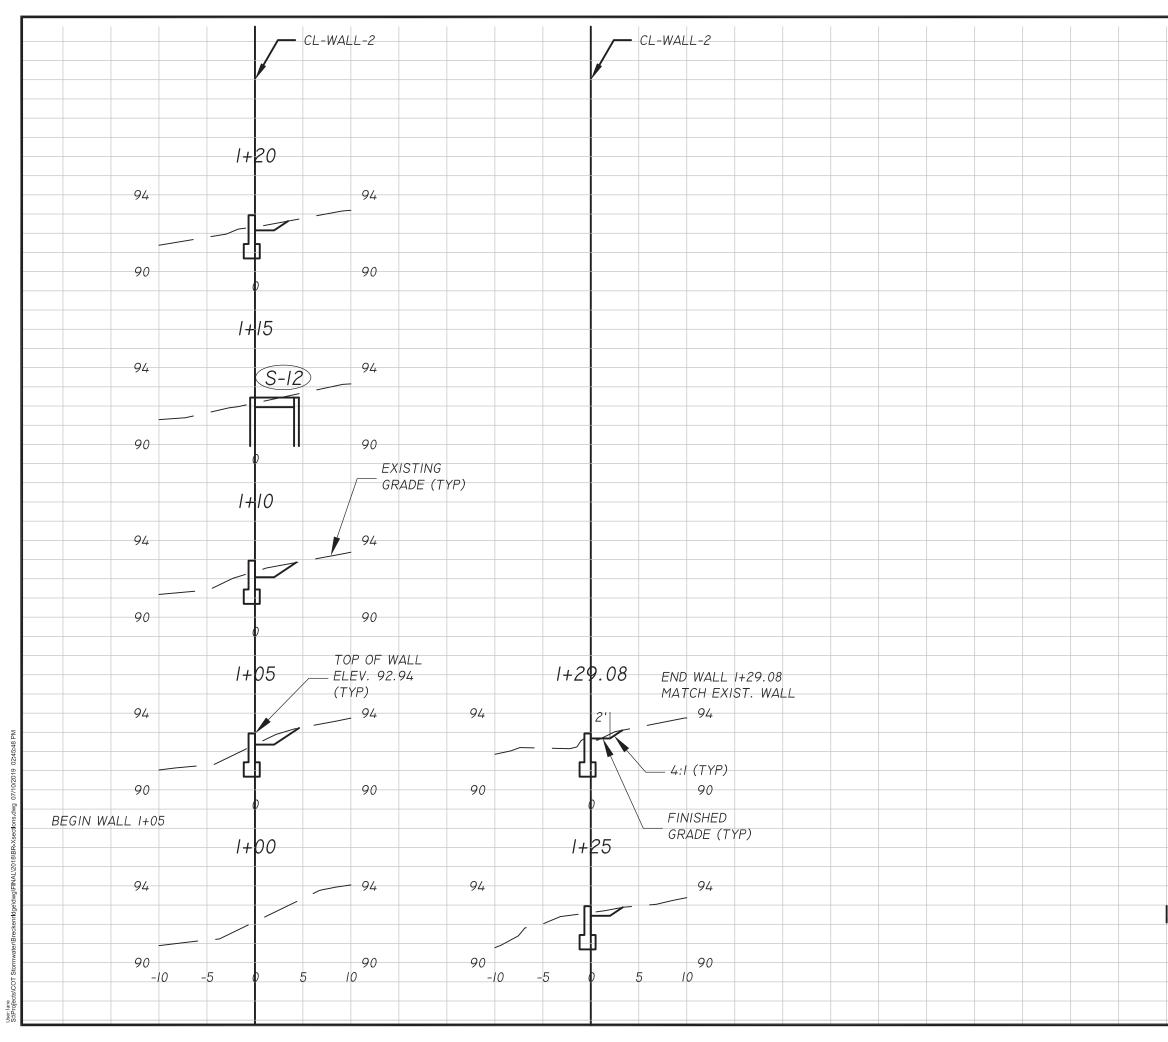

9 9 9 9 9 9 9 9 9 9 9 9 9 9 9 9 1 1 1 1 9 1 1 1 1 9 1 1 	SB Crice	Date
	RECC I UCAS 193366	
	EER OF Inglaw Inglaw Sulle 2 Sulle 2	prature
	NGINE LAN Tallah	ເຮັ
Biggeneration Biggeneration Biggeneration Biggeneration Biggeneration Biggeneration Biggeneration Biggeneration Contribute of Authorization Biggeneration Biggeneration Biggeneration		
Biggeneration Biggeneration Biggeneration Biggeneration Biggeneration Biggeneration Biggeneration Biggeneration Contribute of Authorization Biggeneration Biggeneration Biggeneration		
Biggeneration Biggeneration Biggeneration Biggeneration Biggeneration Biggeneration Biggeneration Biggeneration Contribute of Authorization Biggeneration Biggeneration Biggeneration	lion and line and lin	
Deland		4 U
Display and addition Display addition Display addition Display addition Display addition Display addition Display addition Display addition Display addition Display addition Display addition Display addition Display addition Display addition Display addition Display addition Display addit Display addition Displ		
Deland		
Deland		
Deland		3
Deland		C C
Deland		L L
Deland		
Description Description Description Description		
Definition #9061	REE S	
Definition #9061	(0)	
Definition #9061	X X X X X X X X X X X X X X X X X X X	
Definition #9061	ME	
Definition #9061		
Definition #9061	ш. Эр	
Definition #9061		
Definition #9061		
Definition #9061	⊢ USA	
Definition #9061		
DE22 Reministra Director of Authori Certificate of Authori		
DE22 Reministra Director of Authori Certificate of Authori	2 4400	
DE22 Reministra Director of Authori Certificate of Authori	Arer 383-0	сот 961
DE22 Reministra Director of Authori Certificate of Authori	(0988) XA VA	awinc. #9
Designed over Utrustress Transportation of Authori Certificate of Authori		ww.eut
IUFT JOB NO. DRAWN DRAWN DESIGNED CHECKED QC QC		w oriz(
IUFT JOB NO. DRAWN DRAWN DESIGNED CHECKED QC QC		Auth
IUFT JOB NO. DRAWN DRAWN DESIGNED CHECKED QC QC		of ,
IUFT JOB NO. DRAWN DRAWN DESIGNED CHECKED QC QC		s :ate
IUFT JOB NO. DRAWN DRAWN DESIGNED CHECKED QC QC		3230£ rtific
IUFT JOB NO. DRAWN DRAWN DESIGNED CHECKED QC QC		Ce
IUFT JOB NO. DRAWN DRAWN DESIGNED CHECKED QC QC		sser, f
IUFT JOB NO. DRAWN DRAWN DESIGNED CHECKED QC QC	1822 R	ALLAHAS
DRAWN DRAWN DESIGNED OPERATION		
CHECKED QC	DRAWN	
	CHECKED	
16		
	16	

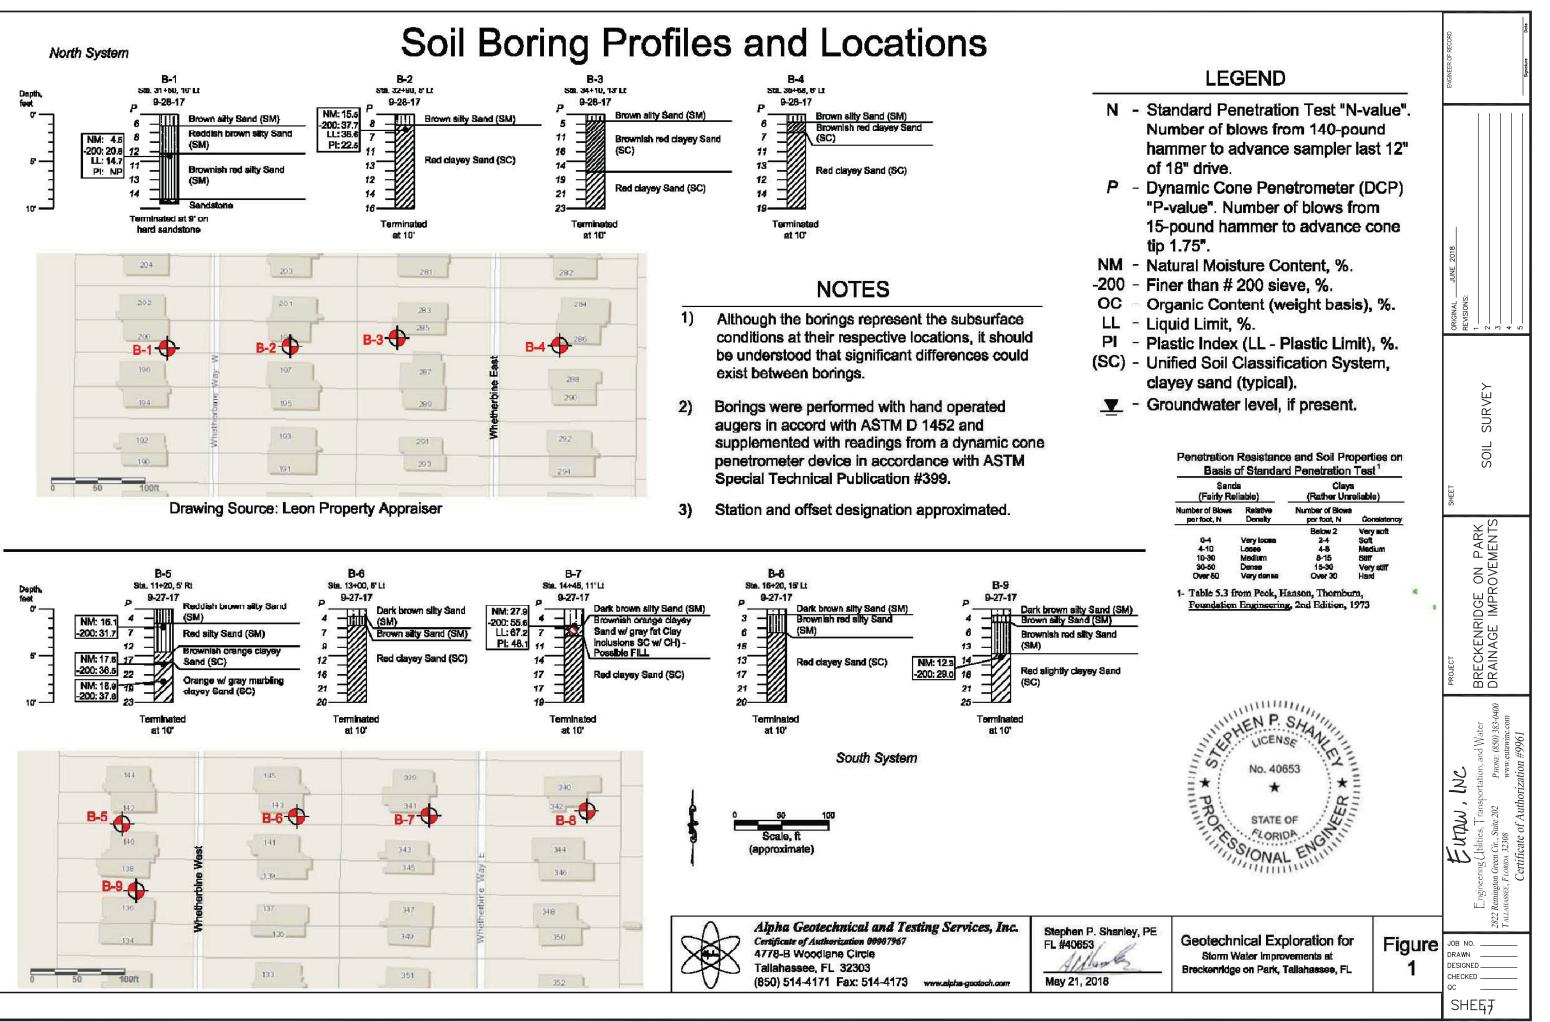

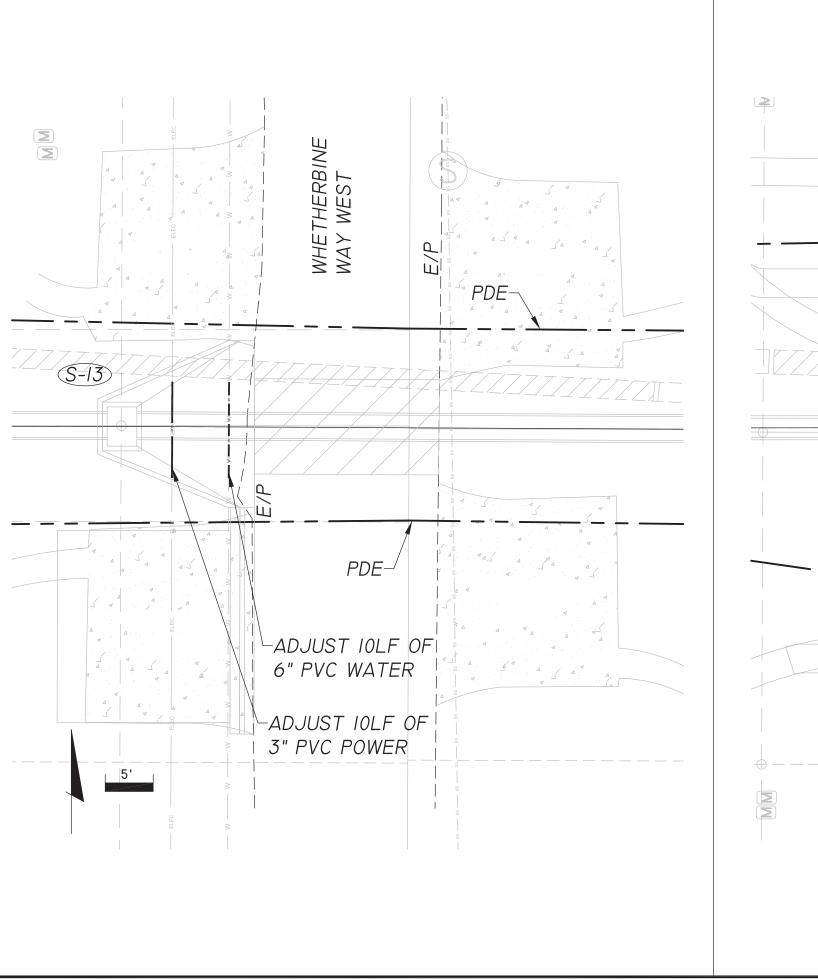

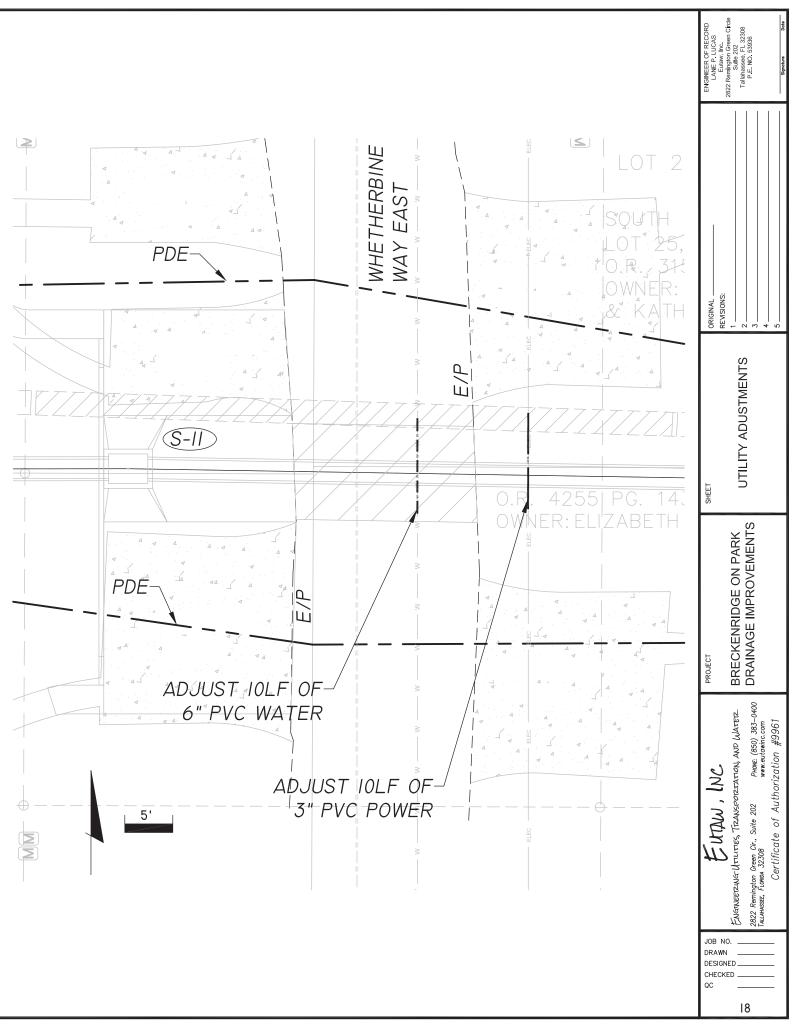

aer lane :Projects\COT StormwatenBreckenrtdge\dwg\FINAL\2018\BR-Plan&Profile.dwg 07/11/2019 05:48:13 PM

I. SITE DESCRIPTION

A. CONSTRUCTION ACTIVITY:

THE PROJECT CONSISTS OF RECONSTRUCTING EXISTING DRAINAGE INFRASTRUCTURE THROUGH AN EXISTING RESIDENTIAL DEVELOPMENT. THE PROJECT INCLUDES CLEARING AND GRUBBING, REMOVAL OF EXISTING DRAINAGE STRUCTURES, INSTALLATION OF DRAINAGE STRUCTURES AND PIPING, ROADWAY RECONSTRUCTION (PATCHING), UTILITY ADJUSTMENTS, MINOR STORMWATER POND RE-GRADING, RETAINING WALL CONSTRUCTION, AND PERMANENT EROSION CONTROL FEATURES.

B. MAJOR SOIL DISTURBING ACTIVITIES:

CLEARING AND GRUBBING DRAINAGE STRUCTURES AND PIPING (REMOVAL AND INSTALLATION) POND RE-GRADING

C. AREA ESTIMATES:

TOTAL PROJECT AREA: 0.87 ACRES TOTAL AREA TO BE DISTURBED: 0.37 ACRES

D. RUNOFF DATA:

RUNOFF COEFFICIENT (BEFORE CONSTRUCTION): 0.45 RUNOFF COEFFICIENT (DURING CONSTRUCTION): 0.48 RUNOFF COEFFICIENT (AFTER CONSTRUCTION): 0.45

OUTFALL LOCATIONS:

THE PROJECT HAS ONE (I) OUTFALLTO THE PARK AVENUE TRIBUTARY #2 N 30°26'48.4" W 84°I3'52.4" 2. CONTROLS

SEQUENCE OF SOIL DISTURBING ACTIVITIES AND IMPLEMENTATION OF CONTROLS:

CONTROLS SHALL BE INSTALLED PRIOR TO ANY EARTH CLEARING ACTIVITIES AND MAINTAINED UNTIL PERMANENT EROSION CONTROL FEATURES HAVE BEEN ESTABLISHED.

A. EROSION AND SEDIMENT CONTROLS

(I) STABILIZATION PRACTICES:
TEMPORARY SODDING
TEMPORARY GRASSING
PERMANENT SODDING OR SEEDING
(2) STRUCTURAL PRACTICES:
SEDIMENT BARRIER
INLET PROTECTION SYSTEM
BERMS
SEDIMENT TRAPS/BASINS

B. STORMWATER MANAGEMENT

STORMWATER MANAGEMENT IS PROVIDED IN THE UPPER AREAS OF THE PROJECT AREA (EXISTING STORMWATER FACILITIES). THESE FACILITIES WILL BE MODIFIED BY THE PROJECT, BUT NO REDUCTION OF TREATMENT/ATTENUATION CAPACITIES IS PROPOSED. NO NEW STORMWATER MANAGEMENT FACILITIES WILL BE CONSTRUCTED AS THERE IS NO NEW IMPERVIOUS AREA ASSOCIATED WITH THE PROJECT.

C. OTHER CONTROLS

(I) WASTE DISPOSAL: THE CONTRACTOR IS RESPONSIBLE FOR DOCUMENTING THIS PORTION OF THE SWPPP.

(2) OFFSITE VEHICLE TRACKING AND GENERATION OF DUST: HAUL ROADS DAMPENED FOR DUST CONTROL LOADED HAUL TRUCKS TO BE COVERED WITH TARP EXCESS DIRT ON ROADWAY REMOVED DAILY STABILIZED CONSTRUCTION ENTRANCE

ALL SANITARY WASTE WILL BE COLLECTED AS NECESSARY OR AS REQUIRED BY LOCAL REGULATION BY A LICENSED SANITARY WASTE MANAGEMENT CONTRACTOR. THE CONTRACTOR IS RESPONSIBLE FOR DOCUMENTING THIS PORTION OF THE SWPPP.

(4) FERTILIZER:

FERTILIZER SHALL BE APPLIED ACCORDING TO THE MANUFACTURER'S RECOMMENDATIONS BY A LICENSED OR CERTIFIED APPLICATOR AS DIRECTED BY THE PROJECT ENGINEER.

(5) PESTICIDES:

THE CONTRACTOR IS RESPONSIBLE FOR DOCUMENTING THIS PORTION OF THE SWPPP.

(6) NON-STORM WATER DISCHARGE INCLUDING SPILL REPORTING: NO NON-STORM WATER DISCHARGES ARE ANTICIPATED. 3. PERM

PERMITS OBTA

4. MAIN

ALL EROSION FOLLOWING E SHALL BE MAN CONTROLS SH

THE CONTRAC PORTION OF T

5. INSP

ALL CONTROL CONTRACTOR OR MORE OF F WILL BE MADE RESULTS. TH INSPECTION R.


MITS AINED FOR THIS PROJECT INCLUDE:	EVALUES: P. C. PECORD LAKE P. LUCAS: P. E. LAKE P. LUCAS: P. E. 2322 Renningion Green Circle 2322 Renningion Green Circle 7 allahasse, F. 2308 P.E. NO. 53396 5 P.E. NO. 53396
NTENANCE I AND SEDIMENT CONTROLS SHALL BE INSPECTED EACH RAINFALL EVENT. ANY REQUIRED REPAIRS ADE IMMEDIATELY. SEDIMENT DEPOSITS AT THE HOULD BE REMOVED AFTER EACH STORM EVENT. CTOR IS RESPONSIBLE FOR DOCUMENTING THIS THE SWPPP.	ORIGINAL REVISIONS: 1 2 2 4 6
PECTION US SHALL BE INSPECTED WEEKLY BY THE A AS WELL AS AFTER A STORM EVENT WITH 0.50" RAIN. AN INSPECTION AND MAINTENANCE REPORT PER EACH INSPECTION BASED UPON INSPECTION HE CONTROLS SHALL BE REVISED PER THE RESULTS.	BRECKENRIDGE ON PARK DRAINAGE IMPROVEMENTS PREVENTION PLAN
	B P


THESE PLANS. THE SEDIMENT AND EROSION CONTROL PLAN SHALL BE PREVARED IN ACCORDANCE WITH THE "FLORIDA EROSION AND SEDIMENT AND EROSION CONTROL PLAN SHALL BE SPECIFIC TO THE MEANS, METHODS, AND SEQUENCE OF CONSTRUCTION TO BE EMPLOYED BY THE CONTRACTOR AND SHALL IDENTIFY THE TYPES AND LOCATIONS OF CONTROLS THAT ARE TO BE IMPLEMENTED DURING EACH PHASE OF CONSTRUCTION AS SHOWN ON THE APPROVED CONSTRUCTION SCHEDULE TO MINIMIZE EROSION, PREVENT THE TRANSFER OF ERODED MATERIALS ONTO ANY OFF SITE PARCEL OR INTO ANY RECEIVING WATER, AND PREVENT VIOLATING STATE AND/OR FEDERAL PERMIT REQUIREMENTS. PAYMENT FOR PREPARING AND SUBMITTING THE SEDIMENT AND EROSION CONTROL PLAN AND FOR ANY MODIFICATIONS TO THE SEDIMENT AND EROSION CONTROL PLAN DURING CONSTRUCTION WILL BE INCLUDED IN THE PAY ITEM FOR MOBILIZATION. THE SEDIMENT AND EROSION CONTROL PLAN SHALL DESCRIBE BUT NOT BE LIMITED TO THE FOLLOWING ITEMS FOR EACH PHASE OF CONSTRUCTION OPERATIONS OR ACTIVITIES.


- POLLUTANTS OFF SITE OR INTO ANY RECEIVING WATER AND SHALL SUBMIT THE UPDATED PLAN FOR REVIEW AND APPROVAL BY THE ENGINEER.
- ENGINEER


- WEATHER, AND AREAS OUTSIDE THE LIMITS OF CONSTRUCTION SHALL NOT BE DISTURBED.


- FILTERS SHALL BE PLACED ACROSS THE THROATS OF ALL EXISTING AND COMPLETED CURB INLETS.
- FLOWS FROM THE EXISTING PIPES TO THE NEW PIPES PRIOR TO RAIN STORMS. TEMPORARY PIPES SHALL BE PLACED FOR THIS PURPOSE PRIOR TO SUSPENSION OF WORK ACTIVITIES EACH DAY.
- HAS TEMPORARILY OR PERMANENTLY CEASED.
- CONSTRUCTION.

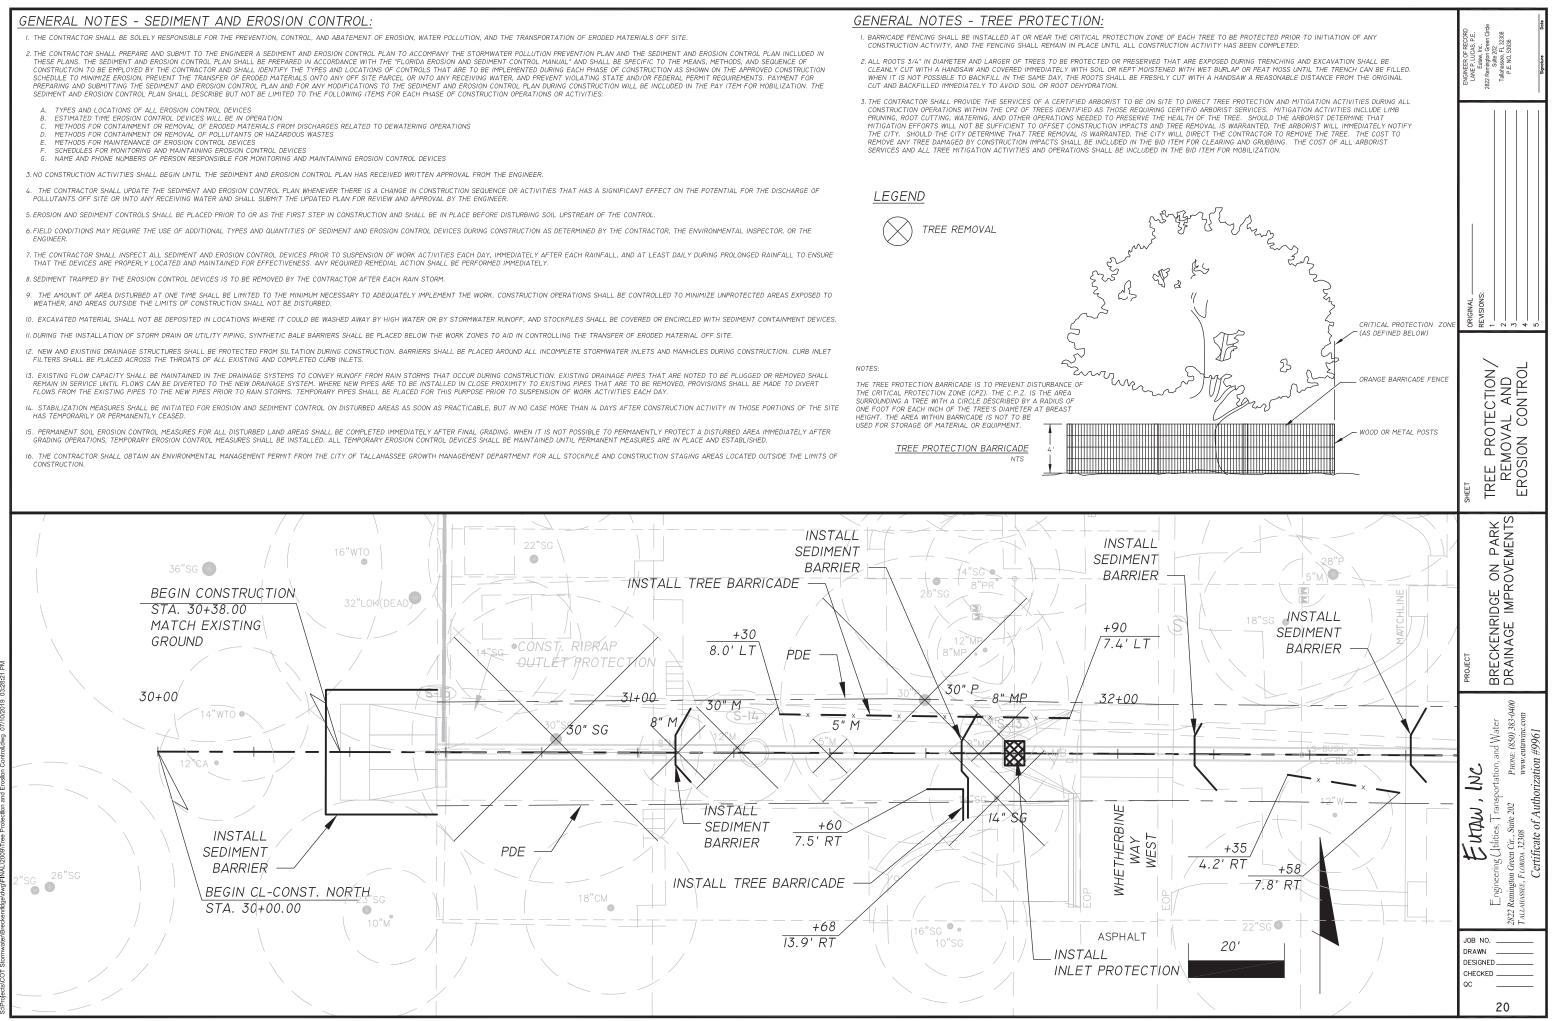

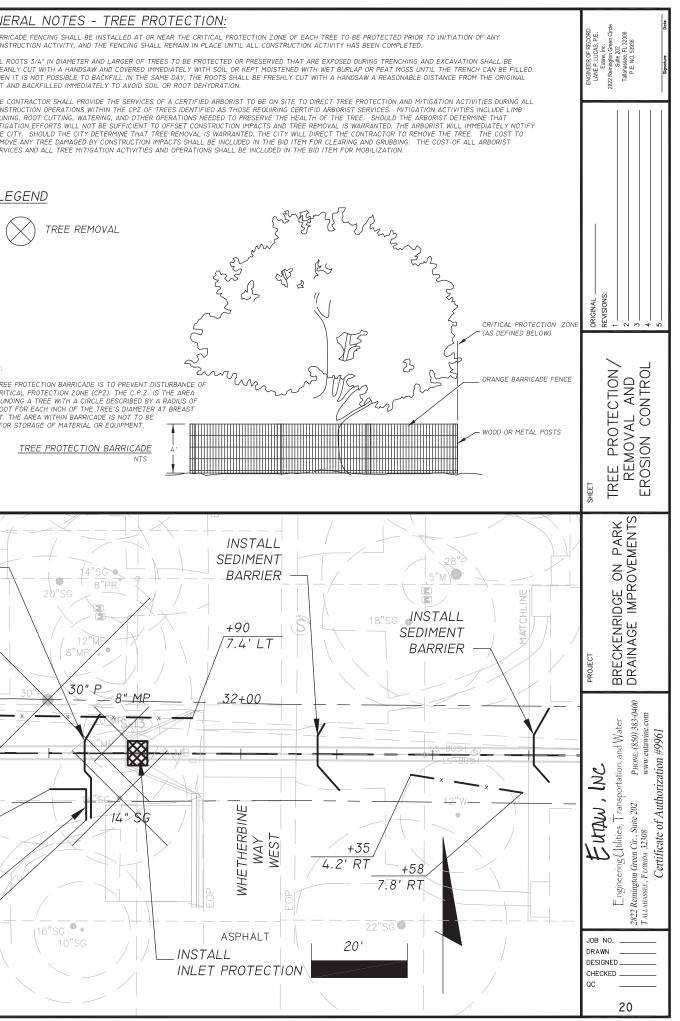

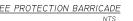

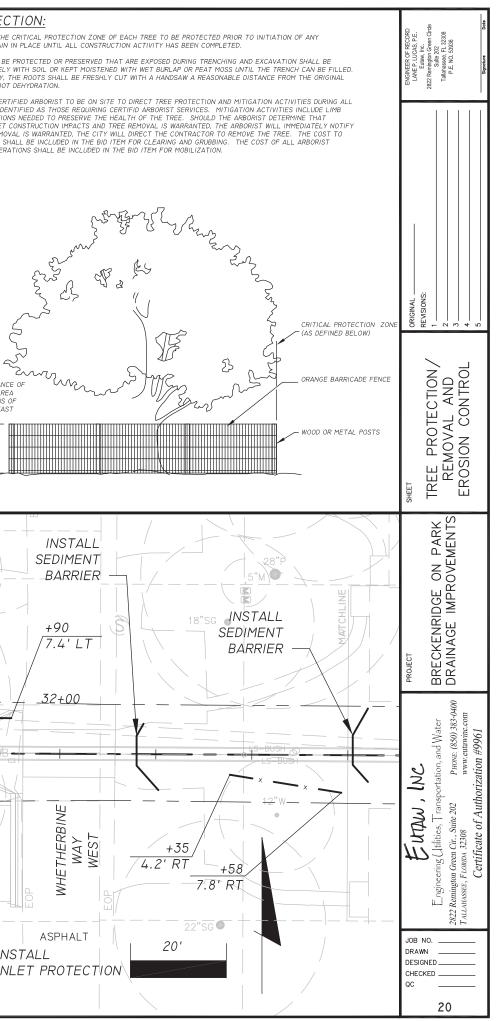

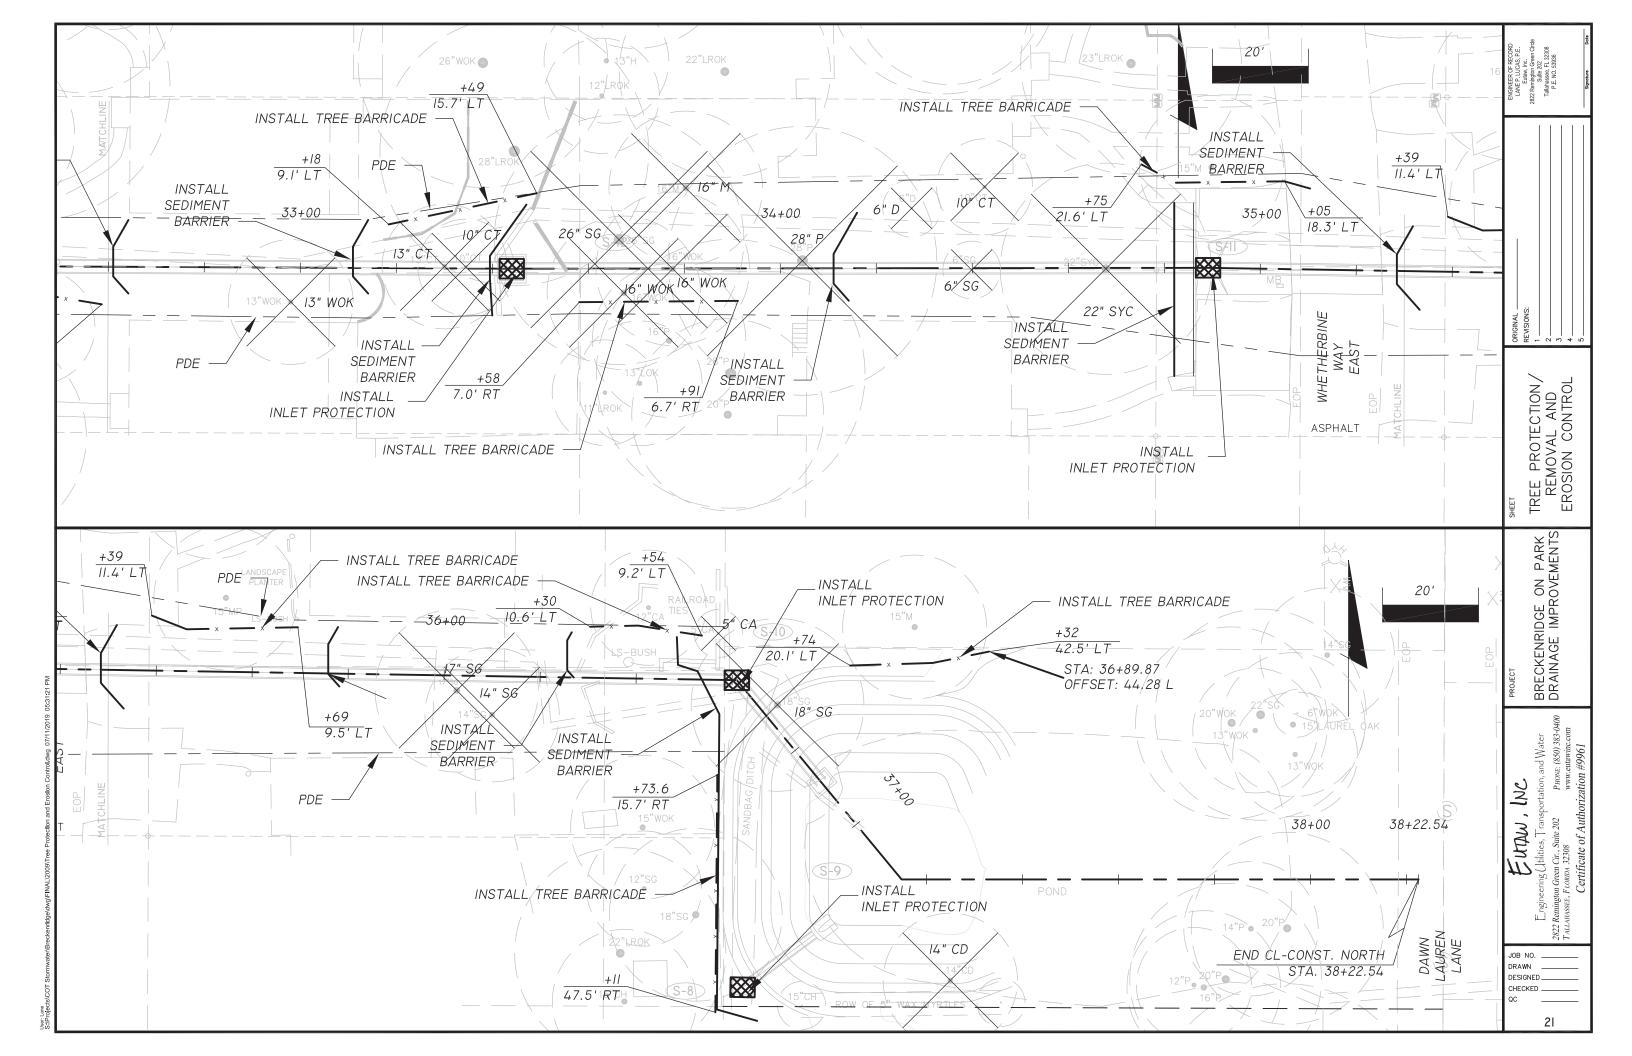


TRAFFIC CONTROL NOTES

- THE CONTRACTOR SHALL PREPARE A TRAFFIC CONTROL PLAN THAT DESCRIBES THE MEASURES TO BE EMPLOYED DURING 1 CONSTRUCTION TO WARN MOTORISTS AND PEDESTRIANS OF HAZARDS. TO ADVISE MOTORISTS OF THE PROPER TRAVEL PATH THROUGH OR AROUND THE WORK AREA, TO DELINEATE AREAS WHERE TRAFFIC SHOULD NOT OPERATE, AND TO SEPARATE AND PROTECT MOTORISTS, PEDESTRIANS, AND THE WORK FORCE DURING ALL PHASES OF THE WORK. THE PLAN SHALL ALSO CONSIDER ACCESS TO BUSINESSES WITHIN THE CONSTRUCTION AREA AND PROVIDE BUSINESS ENTRANCE SIGNS TO ROUTE MOTORISTS TO DESIGNATED PARKING AREAS. THE CONTRACTOR SHALL OBTAIN APPROVAL OF THE TRAFFIC CONTROL PLAN FROM THE CITY OF TALLAHASSEE TRAFFIC MOBILITY MANAGEMENT SECTION PRIOR TO BEGINNING CONSTRUCTION. PAYMENT FOR PREPARING AND SUBMITTING THE TRAFFIC CONTROL PLAN SHALL BE INCLUDED IN THE PAY ITEM FOR MOBILIZATION.
- 2. ACCESS TO BUSINESS AND RESIDENTIAL DRIVEWAYS SHALL BE MAINTAINED AT ALL TIMES.
- 3. NO ROADWAYS (INCLUDING COUNTY ROADS) SHALL BE CLOSED WITHOUT PRIOR APPROVAL OF THE CITY OF TALLAHASSEE TRAFFIC MOBILITY MANAGEMENT SECTION.
- 4. ALL TRAFFIC CONTROL DEVICES SHALL BE INSTALLED IN ACCORDANCE WITH THE MANUAL ON UNIFORM TRAFFIC CONTROL DEVICES AND/OR THE FLORIDA DEPARTMENT OF TRANSPORTATION DESIGN STANDARDS, 600 SERIES.
- 5. ALL TRAFFIC CONTROL DEVICES SHALL BE IN PLACE BEFORE THE START OF CONSTRUCTION ON AFFECTED ROADWAYS.
- WARNING LIGHTS SHALL BE USED ON BARRICADES DURING HOURS OF DARKNESS IN ACCORDANCE WITH INDEX NO. 600. 6.
- ON WHETHERBINE WAY EAST AND WEST, ROADWAY SEGMENTS UNDER CONSTRUCTION MAY BE CLOSED TO THROUGH TRAFFIC. ONLY 7 ONE PORTION OF WHETHERBINE WAY MAY BE CLOSED AT ANY TIME.
- WORK SHALL BE SCHEDULED WHERE ONLY ONE ROADWAY SEGMENT IS UNDER CONSTRUCTION AT A TIME. 8.
- 9. ALL SIGNING AND ADVANCE WARNING SHALL BE INSTALLED PRIOR TO CLOSING ROAD SEGMENTS.

SUGGESTED CONSTRUCTION SEQUENCE

THE FOLLOWING SEQUENCE IS RECOMMENDED FOR THE CONSTRUCTION OF THE PROPOSED IMPROVEMENTS:

- INSTALL EROSION CONTROL FEATURES
- 2. CLEARING AND GRUBBING
- 3. UTILITY ADJUSTMENTS
- 4. STORM SEWER CONSTRUCTION 5. RETAINING WALL CONSTRUCTION
- 6. POND GRADING
- 7
- ROADWAY STABILIZATION 8. OPTIONAL BASE CONSTRUCTION
- 9. CURB CONSTRUCTION
- 10. DRIVEWAY CONSTRUCTION
- II. PERMANENT EROSION CONTROL

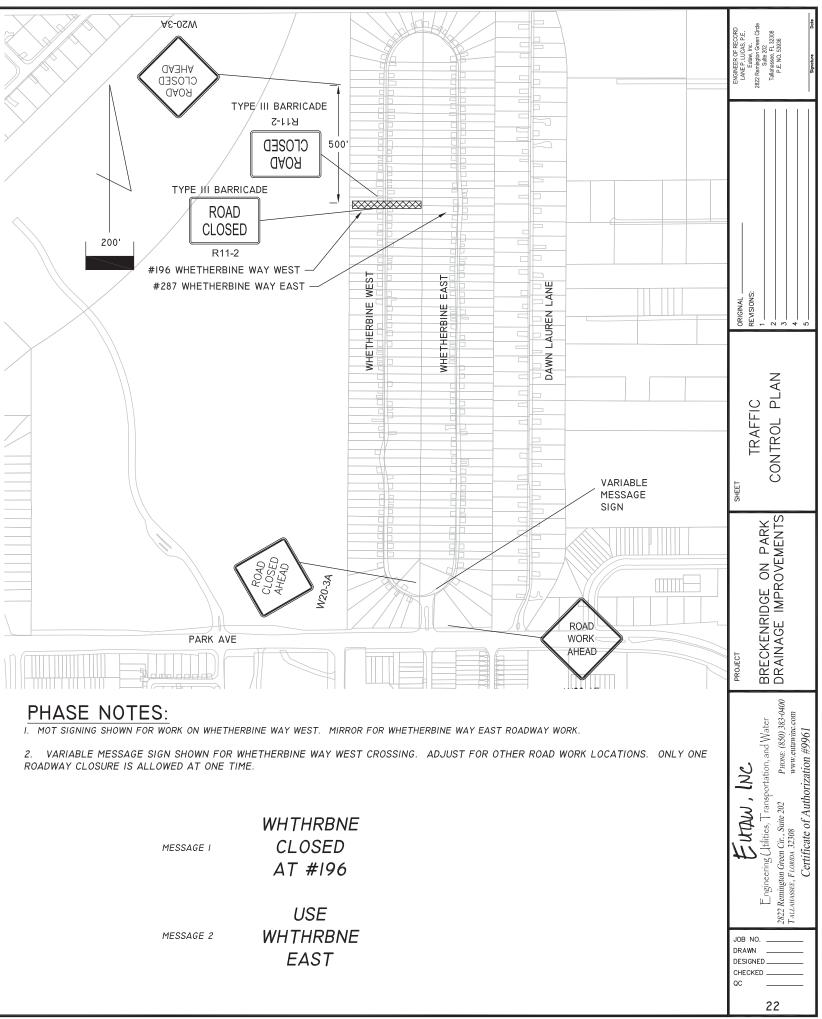

GE I	CLOSED AT #196
	USE
GE 2	WHTHRBN
	FAST